

# 2 Mark St, 1-3 Marsden St, Lidcombe

# **zhinar**chitects

# DEVELOPMENT APPLICATION Residential Flat Building 2 Mark St, 1-3 Marsden St, Lidcombe

# DEVELOPMENT SUMMARY

			2 441 m2 (approx.)	
FSR CALCULATION	Permissible max. FS	SR =	5 : 1	
PROPOSED FLOOR AR	EA Ground Floor Level 1-3 Level 4-7 Level 8 Level 9		1,117.65 m2 1,234.28 m2 x 3 = 3,702.84 n 1,207.27 m2 x 4 = 4,829.08 1,051.47 m2 1,010.33 m2	
	TOTAL PROPOSED	) AREA	11,711.37 m2(FSR 4.8:1)	
BUILDING HEIGHT	Permissible Proposed		32 m 33 m to the top of lift overun	
BUILDING SETBACKS ( Corner setback (Mark St Eastern setback Northern setback (Marsde	& Marsden St) - Southern and Weste		Level 4-7 = 6m setback and 9	etback and 6.05m to the laneway centreline 05m to the laneway centreline 2.05m to the laneway centreline
BASEMENT SETBACKS	: 6m setback at North	Eastern corner ( dee	p soil)	
COMMERCIAL AREAS	540.23 m2			
DEEP SOIL AREA LANDSCAPED AREAS	200 m2 (8.2%) 400.57 m2 (16.41%)	I		
COMMON OPEN SPACE	611.17 m2(25%)a	t rooftop terrace		
	TON = (Auburn DCD 2010)			PARKING CALCULATION
PARKING CALCULAT	<u>10N</u> - ( Auburn DCP 2010 )			( ADG & Guide to Traffic Gene
PARKING CALCULAT	Min. No. of Parking	Max. M	No. of Parking	( ADG & Guide to Traffic Gene
		63 x 1 space	e = 63 spaces	0.4 x 1BR = 0.4 x 63 = 26 car s 0.7 x 2BR = 0.7 x 74 = 52 car s 1.2 x 3BR = 1.2 x 12 = 15 car s
No.of Bedrooms 1BR - 63 units	Min. No. of Parking 63 x 1 space = 63 spaces	63 x 1 space 74 x 3 space	e = 63 spaces es = 222 spaces	0.4 x 1BR = 0.4 x 63 = 26 car s 0.7 x 2BR = 0.7 x 74 = 52 car s
No.of Bedrooms 1BR - 63 units 2BR - 74 units	Min. No. of Parking 63 x 1 space = 63 spaces 74 x 1.2 spaces = 89 spaces	63 x 1 space 74 x 3 space	e = 63 spaces es = 222 spaces es = 48 spaces	0.4 x 1BR = 0.4 x 63 = 26 car s 0.7 x 2BR = 0.7 x 74 = 52 car s 1.2 x 3BR = 1.2 x 12 = 15 car s

- 218 residents parking -
- 13 visitor parking -9 commercial parking -
- Bicycle parking (min. 1 space/5 units) -

= 30 spaces (provided)

Storage cages

= 268 cages

•	Storage cages	

Development Application
Original Design: Zhinar Architects

DA-D	DRAWINGS AMENDED AS PER JRPP COMMENTS.	27/06/2018	ΥT	AHM
DA-C	DRAWINGS AMENDED AS PER COUNCIL RFI - MAY '18. AMENDMENTS SHOWN CLOUDED.	23/05/2018	ΥT	AHM
DA-B	DRAWINGS AMENDED. ISSUED FOR COUNCIL REVIEW.	13/04/2018	ΥT	AHM
DA-A	ISSUED FOR DEVELOPMENT APPLICATION	21/11/2017	ΥT	AHM
ISSUE	AMENDMENT	DATE	DRAWN	CHECKED
		Drawing is NOT V/	ALID or issued for u	se, unless checked.



## LInit Mix / Yield

<u>Unit Mix</u>						
					01	Cover Sheet
					02	Street Views ( Existing & Future Context )
	1BR	2BR	3BR	Total	03	Site Analysis 01
					04	Site Analysis 02
Ground	1 unite (1AD)		3 unite (1AD)	1 units	05	Basement 4 Plan
	· · ·		S units (TAD)		06	Basement 3 Plan
					07	Basement 2 Plan
	32 units (4AD)				08	Basement 1 Plan
L8		10 units (1Al	D) 4 units	14 units	09	Site Plan
L9		8 units (2A	D) 1 unit	9 units	10	Ground FI Plan
					11	Level 1-3 Plan (Typical)
Total	63 units (42.3%)	74 units (49.7	%) 12 units (8%)	149 units (100%)	12	Level 4-7 Plans (Typical)
					13	Level 8 Plan
I		1			14	Level 9 Plan
* 15 Adap	table-l ivable l Inits pro	vided (10%) &	extra 15 Livable Units provided	(10%)	15	Roof Plan
					16	Top Roof Plan
					17	South Elevation
					18	North Elevation - Marsden St
					19	West Elevation - Mark St
Basix Building Fabric Requirements: 2 Mark St and 1-3 Marsden St				20	East Elevation	
					21	Section A
		Element	Material Type	Detail	22	Section B
		External walls	Hebel Powerpanel + R2.0 Insulation + PB	Dark colour	23	Section C
		Internal walls	Plasterboard on studs	Intra-tenancy walls	24	Shadow Diagrams (Existing Context)
			Hebel Powerpanel + R2.0 Insulation + PB	Inter-tenancy walls	25A	Shadow Diagrams (Winter Solstice) - 09AM-12PM
		Windows	ALM-002-01 A Aluminium B SG Clear	NFRC Glazing System values:	25B	Shadow Diagrams (Winter Solstice) - 1PM-3PM
				$\Rightarrow$ 0 $\leq$ 6.70 and SHGC = 0.70 (± 10%)		
					25C	Current Solar Access to Existing 10-14 Marsden St
			Aluminium B SG High Solar Gain Low-E	NFRC Glazing System values: $\rightarrow$ U < 5.40 and SHGC = 0.58 (+ 10%)	25C 25D	Current Solar Access to Existing 10-14 Marsden St Shadow Impact to 10-14 Marsden St (Winter Solstice)
			Aluminium B SG High Solar Gain Low-E	$\Rightarrow$ U $\leq$ 5.40 and SHGC = 0.58 (± 10%)		·
			Aluminium B SG High Solar Gain Low-E		25D	Shadow Impact to 10-14 Marsden St (Winter Solstice)
		Skylights	Aluminium B SG High Solar Gain Low-E Single Glazed Clear	<ul> <li>⇒ U ≤ 5.40 and SHGC = 0.58 (± 10%)</li> <li>Modifying units: 1.01, 1.14, 2.01, 2.14,</li> </ul>	25D 25E	Shadow Impact to 10-14 Marsden St (Winter Solstice) Indicative Future Context of 10-14 Marden St
		Skylights Downlights		<ul> <li>⇒ U ≤ 5.40 and SHGC = 0.58 (± 10%)</li> <li>Modifying units: 1.01, 1.14, 2.01, 2.14,</li> </ul>	25D 25E 25F	Shadow Impact to 10-14 Marsden St (Winter Solstice) Indicative Future Context of 10-14 Marden St Shadow Impact to 10-14 Marsden St (FUTURE CONTEXT
		Downlights	Single Glazed Clear Deafuilt as BASIX protocol	⇒ U ≤ 5.40 and SHGC = 0.58 (± 10%) Modifying units: 1.01, 1.14, 2.01, 2.14, 3.01, 3.14, 8.04, 8.05, 8.12, 8.13, 8.14 Sealed option	25D 25E 25F 25G	Shadow Impact to 10-14 Marsden St (Winter Solstice) Indicative Future Context of 10-14 Marden St Shadow Impact to 10-14 Marsden St (FUTURE CONTEXT Shadow Impact to 4-14 Mark St (Winter Solstice)
			Single Glazed Clear	⇒ U ≤ 5.40 and SHGC = 0.58 (± 10%) Modifying units: 1.01, 1.14, 2.01, 2.14, 3.01, 3.14, 8.04, 8.05, 8.12, 8.13, 8.14	25D 25E 25F 25G 25H	Shadow Impact to 10-14 Marsden St (Winter Solstice) Indicative Future Context of 10-14 Marden St Shadow Impact to 10-14 Marsden St (FUTURE CONTEXT Shadow Impact to 4-14 Mark St (Winter Solstice) Shadow Impact to 4-14 Mark St (Winter Solstice)
		Downlights	Single Glazed Clear Deafuilt as BASIX protocol Concrete slab Concrete slab + R1.0 Insulation (Below car	⇒ U ≤ 5.40 and SHGC = 0.58 (± 10%) Modifying units: 1.01, 1.14, 2.01, 2.14, 3.01, 3.14, 8.04, 8.05, 8.12, 8.13, 8.14 Sealed option Tile (kitchen & wet)	25D 25E 25F 25G 25H 25H	Shadow Impact to 10-14 Marsden St (Winter Solstice) Indicative Future Context of 10-14 Marden St Shadow Impact to 10-14 Marsden St (FUTURE CONTEXT Shadow Impact to 4-14 Mark St (Winter Solstice) Shadow Impact to 4-14 Mark St (Winter Solstice) FUTURE CONTEXT
		Downlights Floor	Single Glazed Clear Deafuilt as BASIX protocol Concrete slab Concrete slab + R1.0 Insulation (Below car park and outside air)	<ul> <li>⇒ U ≤ 5.40 and SHGC = 0.58 (± 10%)</li> <li>Modifying units: 1.01, 1.14, 2.01, 2.14, 3.01, 3.14, 8.04, 8.05, 8.12, 8.13, 8.14</li> <li>Sealed option</li> <li>Tile (kitchen &amp; wet)</li> <li>Laminated Timber (bedrooms and living)</li> </ul>	25D 25E 25F 25G 25H 25H 25I 25J	<ul> <li>Shadow Impact to 10-14 Marsden St (Winter Solstice)</li> <li>Indicative Future Context of 10-14 Marden St</li> <li>Shadow Impact to 10-14 Marsden St (FUTURE CONTEXT</li> <li>Shadow Impact to 4-14 Mark St (Winter Solstice)</li> <li>Shadow Impact to 4-14 Mark St (Winter Solstice)</li> <li>FUTURE CONTEXT</li> <li>Shadow to Future 10-14 Marsden St</li> </ul>
		Downlights Floor Ceiling +	Single Glazed Clear Deafuilt as BASIX protocol Concrete slab Concrete slab + R1.0 Insulation (Below car park and outside air) Concrete	$\Rightarrow U \le 5.40 \text{ and SHGC} = 0.58 (\pm 10\%)$ Modifying units: 1.01, 1.14, 2.01, 2.14, 3.01, 3.14, 8.04, 8.05, 8.12, 8.13, 8.14 Sealed option Tile (kitchen & wet) Laminated Timber (bedrooms and living) To basement, outside air, carpark	25D 25E 25F 25G 25H 25I 25J 25J	Shadow Impact to 10-14 Marsden St (Winter Solstice) Indicative Future Context of 10-14 Marden St Shadow Impact to 10-14 Marsden St (FUTURE CONTEXT Shadow Impact to 4-14 Mark St (Winter Solstice) Shadow Impact to 4-14 Mark St (Winter Solstice) FUTURE CONTEXT Shadow to Future 10-14 Marsden St Shadow to Future 10-14 Marsden St
		Downlights Floor	Single Glazed Clear Deafuilt as BASIX protocol Concrete slab Concrete slab + R1.0 Insulation (Below car park and outside air)	<ul> <li>⇒ U ≤ 5.40 and SHGC = 0.58 (± 10%)</li> <li>Modifying units: 1.01, 1.14, 2.01, 2.14, 3.01, 3.14, 8.04, 8.05, 8.12, 8.13, 8.14</li> <li>Sealed option</li> <li>Tile (kitchen &amp; wet)</li> <li>Laminated Timber (bedrooms and living)</li> </ul>	25D 25E 25F 25G 25H 25I 25J 25J 25K 26	Shadow Impact to 10-14 Marsden St (Winter Solstice) Indicative Future Context of 10-14 Marden St Shadow Impact to 10-14 Marsden St (FUTURE CONTEXT Shadow Impact to 4-14 Mark St (Winter Solstice) Shadow Impact to 4-14 Mark St (Winter Solstice) FUTURE CONTEXT Shadow to Future 10-14 Marsden St Shadow to Future 10-14 Marsden St GFA Calculation
		Downlights Floor Ceiling + Roof	Single Glazed Clear Deafuilt as BASIX protocol Concrete slab Concrete slab + R1.0 Insulation (Below car park and outside air) Concrete Concrete +R3.0 Insulation (top level)	$\Rightarrow U \le 5.40 \text{ and SHGC} = 0.58 (\pm 10\%)$ Modifying units: 1.01, 1.14, 2.01, 2.14, 3.01, 3.14, 8.04, 8.05, 8.12, 8.13, 8.14 Sealed option Tile (kitchen & wet) Laminated Timber (bedrooms and living) To basement, outside air, carpark	25D 25E 25F 25G 25H 25I 25J 25J 25K 26 27	<ul> <li>Shadow Impact to 10-14 Marsden St (Winter Solstice)</li> <li>Indicative Future Context of 10-14 Marden St</li> <li>Shadow Impact to 10-14 Marsden St (FUTURE CONTEXT</li> <li>Shadow Impact to 4-14 Mark St (Winter Solstice)</li> <li>Shadow Impact to 4-14 Mark St (Winter Solstice)</li> <li>FUTURE CONTEXT</li> <li>Shadow to Future 10-14 Marsden St</li> <li>Shadow to Future 10-14 Marsden St</li> <li>GFA Calculation</li> <li>Solar &amp; Cross Ventilation Diagrams 01</li> </ul>
en in preference to scaling.		Downlights Floor Ceiling +	Single Glazed Clear Deafuilt as BASIX protocol Concrete slab Concrete slab + R1.0 Insulation (Below car park and outside air) Concrete Concrete +R3.0 Insulation (top level)	→ U ≤ 5.40 and SHGC = 0.58 (± 10%)      Modifying units: 1.01, 1.14, 2.01, 2.14,     3.01, 3.14, 8.04, 8.05, 8.12, 8.13, 8.14      Sealed option      Tile (kitchen & wet)     Laminated Timber (bedrooms and living)      To basement, outside air, carpark      Light colour	25D 25E 25F 25G 25H 25J 25J 25K 26 27 28	Shadow Impact to 10-14 Marsden St (Winter Solstice) Indicative Future Context of 10-14 Marden St Shadow Impact to 10-14 Marsden St (FUTURE CONTEXT Shadow Impact to 4-14 Mark St (Winter Solstice) Shadow Impact to 4-14 Mark St (Winter Solstice) FUTURE CONTEXT Shadow to Future 10-14 Marsden St Shadow to Future 10-14 Marsden St GFA Calculation Solar & Cross Ventilation Diagrams 01 Solar & Cross Ventilation Diagrams 02
n with information on first page. on site before commencing wor	rk or ordering materials.	Downlights Floor Ceiling + Roof	Single Glazed Clear Deafuilt as BASIX protocol Concrete slab Concrete slab + R1.0 Insulation (Below car park and outside air) Concrete Concrete +R3.0 Insulation (top level)	→ U ≤ 5.40 and SHGC = 0.58 (± 10%)      Modifying units: 1.01, 1.14, 2.01, 2.14,     3.01, 3.14, 8.04, 8.05, 8.12, 8.13, 8.14      Sealed option      Tile (kitchen & wet)     Laminated Timber (bedrooms and living)      To basement, outside air, carpark      Light colour	25D 25E 25F 25G 25H 25J 25J 25K 26 27 28	<ul> <li>Shadow Impact to 10-14 Marsden St (Winter Solstice)</li> <li>Indicative Future Context of 10-14 Marden St</li> <li>Shadow Impact to 10-14 Marsden St (FUTURE CONTEXT</li> <li>Shadow Impact to 4-14 Mark St (Winter Solstice)</li> <li>Shadow Impact to 4-14 Mark St (Winter Solstice)</li> <li>FUTURE CONTEXT</li> <li>Shadow to Future 10-14 Marsden St</li> <li>Shadow to Future 10-14 Marsden St</li> <li>GFA Calculation</li> <li>Solar &amp; Cross Ventilation Diagrams 01</li> </ul>
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		L1-3       30 units (6AD)         L4-7       32 units (4AD)         L8          L9          Total       63 units (42.3%)	Ground1 units (1AD)L1-330 units (6AD)24 unitsL4-732 units (4AD)32 unitsL810 units (1AD)L98 units (2AD)Total63 units (42.3%)74 units (49.79)* 15 Adaptable-Livable Units provided (10%) & 8ElementExternal wallsInternal wallsInternal walls	Ground       1 units (1AD)        3 units (1AD)         L1-3       30 units (6AD)       24 units          L4-7       32 units (4AD)       32 units       4 units         L8        10 units (1AD)       4 units         L9        8 units (2AD)       1 unit         Total       63 units (42.3%)       74 units (49.7%)       12 units (8%)         * 15 Adaptable-Livable Units provided (10%) & extra 15 Livable Units provided         Eternent         Material Type         External walls       Hebel Powerpanel + R2.0 Insulation + PB         Internal walls       Plasterboard on studs	Ground       1 units (1AD)        3 units (1AD)       4 units         L1-3       30 units (6AD)       24 units        54 units         L4-7       32 units (4AD)       32 units       4 units       68 units         L8        10 units (1AD)       4 units       14 units         L9        8 units (2AD)       1 unit       9 units         Total       63 units (42.3%)       74 units (49.7%)       12 units (8%)       149 units (100%)         * 15 Adaptable-Livable Units provided (10%) & extra 15 Livable Units provided (10%)       Easix Building Fabric Requirements: 2 Mark St and 1-3 Marsden St         Element Material Type Detail         External walls       Hebel Powerpanel + R2.0 Insulation + PB       Dark colour         Inter-lenancy walls       Hebel Powerpanel + R2.0 Insulation + PB       Inter-lenancy walls	IBR         2BR         3BR         Total         03           Ground         1 units (1AD)          3 units (1AD)         4 units         66           L1-3         30 units (6AD)         24 units          54 units         77           L4-7         32 units (4AD)         32 units         4 units         68 units         77           L8          10 units (1AD)         4 units         14 units         19         77           L9          8 units (2AD)         1 unit         9 units         10         11           Total         63 units (42.3%)         74 units (49.7%)         12 units (8%)         149 units (100%)         13           * 15 Adaptable-Livable Units provided (10%) & extra 15 Livable Units provided (10%)         16         16           Easix Building Fabric Requirements: 2 Mark St and 1-3 Marsden St           External walls         Heater Type         Detail           11         10         10         10         12           12         10         10         10         12           * 15 Adaptable-Livable Units provided (10%) & extra 15 Livable Units provided (10%)         12         12           External walls         Heater

Skylights	Single Glazed Clear	Modifying units: 1.01, 1.14, 2.01, 2.14, 3.01, 3.14, 8.04, 8.05, 8.12, 8.13, 8.14	_	25E 25F 25G	Indicative Future Context of 10-14 Marden St Shadow Impact to 10-14 Marsden St (FUTURE CONTEXT) Shadow Impact to 4-14 Mark St (Winter Solstice)
Windows	ALM-002-01 A Aluminium B SG Clear Aluminium B SG High Solar Gain Low-E	NFRC Glazing System values: $\Rightarrow U \le 6.70$ and SHGC = 0.70 (± 10%) NFRC Glazing System values: $\Rightarrow U \le 5.40$ and SHGC = 0.58 (± 10%)	_	25B 25C 25D	Shadow Diagrams (Winter Solstice) - 1PM-3PM Current Solar Access to Existing 10-14 Marsden St Shadow Impact to 10-14 Marsden St (Winter Solstice)
Internal walls	Plasterboard on studs Hebel Powerpanel + R2.0 Insulation + PB	Intra-tenancy walls	_	24 25A	Shadow Diagrams (Existing Context) Shadow Diagrams (Winter Solstice) - 09AM-12PM
Element External walls	Material Type Hebel Powerpanel + R2.0 Insulation + PB	Detail Dark colour	_	22 23	Section B Section C
<u>Basix Building</u>	I Fabric Requirements: 2 Mark St and	<u>1-3 Marsden St</u>		18 19 20 21	North Elevation - Marsden St West Elevation - Mark St East Elevation Section A
ided(10%)&	extra 15 Livable Units provided	( 10% )		14 15 16 17	Level 9 Plan Roof Plan Top Roof Plan South Elevation
74 units (49.7	%) 12 units (8%)	149 units (100%)		11 12 13	Level 1-3 Plan (Typical) Level 4-7 Plans (Typical) Level 8 Plan
32 units 10 units (1A 8 units (2A	,	68 units 14 units 9 units		08 09 10	Basement 1 Plan Site Plan Ground Fl Plan
 24 units	3 units (1AD) 	4 units 54 units	_	05 06 07	Basement 4 Plan Basement 3 Plan Basement 2 Plan
2BR	3BR	Total		02 03 04	Street Views ( Existing & Future Context ) Site Analysis 01 Site Analysis 02

Cover	Sneet			
DESIGNED:	DRAWN:	COMMENCED:	SCALE:	PRINT:
AHM	ΥT	May 2017	1:100@A1 1:200@A3 or as noted	A3 SHEET
L.G.A: Cum	berland	Council	Wednesday, 27 J	PLOT: une 2018 4:17 PM

## nerating Developments ) - CBD Centres

r spaces r spaces r spaces

sitor car spaces

s based on Guide to Traffic Generating



Drawing to be read in conjunction with info Check all dimensions and levels on site be All existing ground lines & trees location a Any discrepancies to be verified back to Zh All workmanship and materials shall compl manufacturer's instructions. Unless noted 'Issued for Construction', drawing not to be used for construction. COPYRIGHT: INFORMATION ON THIS DRAWING IS THE COPYRIGHT OF ZHINAR ARCHITECTS. COPYING OR USING THIS DRAWING

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Drawing Schedule

ZHINAR ARCHITECTS Zhinar Architects Pty Ltd ABN: 28 495 869 790 Suite 1 Level 2, 2 Rowe Street (Cnr Ryedale Road), Eastwood NSW 2122 PH: (+61 2) 8893 8888 WEB: www.zhinar.com.au

JOB No.:

8539 DA - D:01

ISSUE:

D





DA-D	DRAWINGS AMENDED AS PER JRPP COMMENTS.	22/06/2018	ΥT	AHM
DA-C	DRAWINGS AMENDED AS PER COUNCIL RFI - MAY '18. AMENDMENTS SHOWN CLOUDED.	23/05/2018	ΥT	AHM
DA-B	DRAWINGS AMENDED. ISSUED FOR COUNCIL REVIEW.	13/04/2018	ΥT	AHM
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ISSUE	AMENDMENT	DATE	DRAWN	CHECKEE
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**STREET VIEWS - EXISTING CONTEXT** 

## **STREET VIEWS - FUTURE CONTEXT**



GENERAL NOTES: GENERAL NOTES: Figured dimensions shall be taken in preference to scaling. Drawing to be read in conjunction with information on first page. Check all dimensions and levels on site before commencing work or ordering materials. All existing ground lines & trees location are approximate, therefore to be verified on-site by the builder. Any discrepancies to be verified back to Zhinar Architects before proceeding. All workmanship and materials shall comply with all relevant codes, ordinances, Australian Standards and manufacturer's instructions. Unless noted 'Issued for Construction', drawing not to be used for construction. COPYRIGHT: INFORMATION ON THIS DRAWING IS THE COPYRIGHT OF ZHINAR ARCHITECTS. COPYING OR USING THIS DRAWING IN WHOLE OR PART WITHOUT WRITTEN PERMISSION INFRINGES COPYRIGHT.

NORTH:

SHEET TITLE: Street Views (Existing & Future Context) DESIGNED: DRAWN: COMMENCED: AHM YT May 2017

SCALE: PRINT: 1:100@A1 A3 SHEET 1:200@A3 or as noted PLOT:

L.G.A: Cumberland Council

Friday, 22 June 2018 2:28 PM



Residential Flat Building 2 Mark St, 1-3 Marsden St Lidcombe, NSW 2141 JOB No.: 8539 DA - D:02





Source: Google Maps



				I
DA-D	DRAWINGS AMENDED AS PER JRPP COMMENTS.	22/06/2018	ΥT	AHM
DA-C	DRAWINGS AMENDED AS PER COUNCIL RFI - MAY '18. AMENDMENTS SHOWN CLOUDED.	23/05/2018	ΥT	AHM
DA-B	DRAWINGS AMENDED. ISSUED FOR COUNCIL REVIEW.	13/04/2018	ΥT	AHM
DA-A	ISSUED FOR DEVELOPMENT APPLICATION	21/11/2017	ΥT	AHM
ISSUE	AMENDMENT	DATE	DRAWN	C HEC KED
		Drawing is NOT VA	ALID or issued for u	se, unless checked.

**Development Application** Original Design: Zhinar Architects

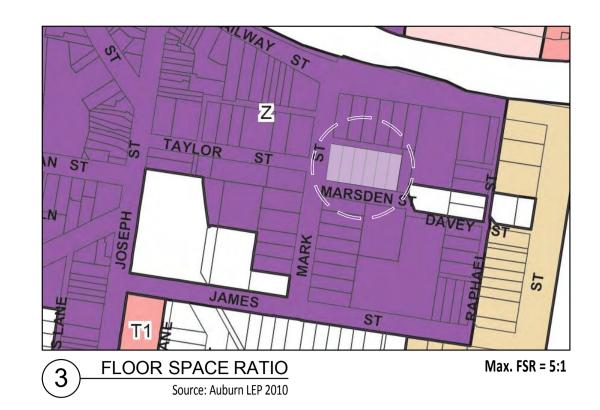

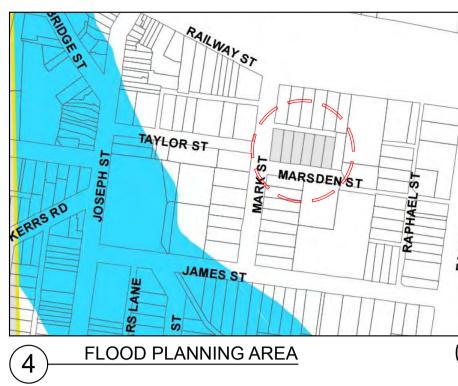



Source: Google Maps

### PROXIMITY TO LOCAL AMENITIES

### To transport node

- Auburn train station is 250m from the site
- Bus stops available at Railway St (in front of train station), corner of James St and Henry St, and at East St.

### To educational facilities

- St Joachim Catholic school is 350m from the site
- Lidcombe Public School is 700m from site

### To town centre


- Auburn town centre is 120m from the site

**To public open space**- Remembrance park is 150m from the site

**To medical centre / hospital**- Lidcombe Medical & Health Centre is 650m from site

- **To community facilities**  Lidcombe public library is 350m from site Dooleys Lidcombe Club is 600m from site



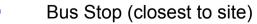

GENERAL NOTES:



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### SHEET TITLE: Site Analysis 01

L.G.A: Cumberland Council

DESIGNED: DRAWN: COMMENCED: AHM YT May 2017

SCALE: PRINT: 1:100@A1 A3 SHEET 1:200@A3 or as noted PLOT: Friday, 22 June 2018 2:28 PM





## Mixed Use (B4)

Max Height 38m



Flood Planning Area

(Not affected)



Lidcombe Town Centre

Lidcombe Train Station

Public park - Remembrance Park

Arterial road

Sub-arterial roads



Residential Flat Building 2 Mark St, 1-3 Marsden St Lidcombe, NSW 2141 JOB No.: 8539 DA - D:03





1. Corner of Mark St & Marsden St SOURCE: GOOGLE STREET VIEW

DA-D	DRAWINGS AMENDED AS PER JRPP COMMENTS.	27/06/2018	ΥT	AHM
DA-C	DRAWINGS AMENDED AS PER COUNCIL RFI - MAY '18. AMENDMENTS SHOWN CLOUDED.	23/05/2018	ΥT	AHM
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DA-A	ISSUED FOR DEVELOPMENT APPLICATION	21/11/2017	ΥT	AHM
ISSUE	AMENDMENT	DATE	DRAWN	CHECKED
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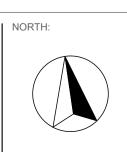
SITE ANALYSIS




2. Mark St - Looking south SOURCE: GOOGLE STREET VIEW



GENERAL NOTES:
Figured dimensions shall be taken in preference to scaling.
Drawing to be read in conjunction with information on first page.
Check all dimensions and levels on site before commencing work or ordering materials.
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Any discrepancies to be verified back to Zhinar Architects before proceeding.
All workmanship and materials shall comply with all relevant codes, ordinances, Australian Standards and manufacturer's instructions.
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3. Mark St - Looking North SOURCE: GOOGLE STREET VIEW

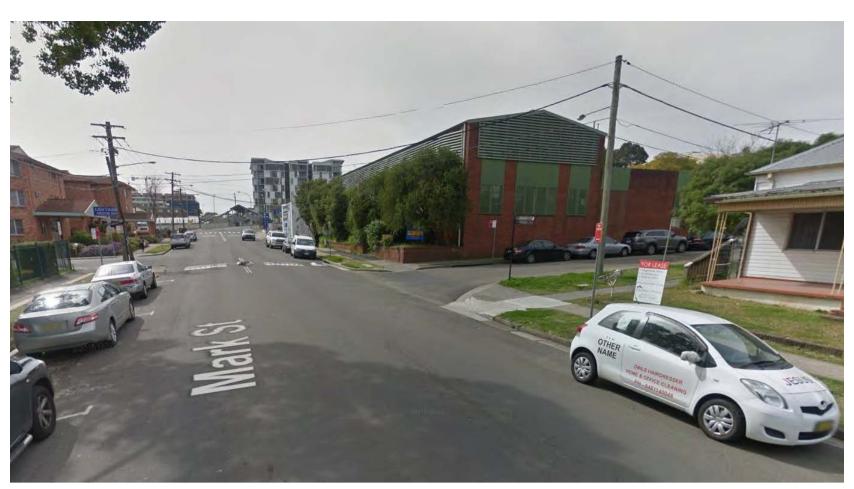

4. Site : 4-8 Mark St SOURCE: GOOGLE STREET VIEW



5. Site : 10-14 Mark St SOURCE: GOOGLE STREET VIEW




6. Corner of Mark St & James St SOURCE: GOOGLE STREET VIEW

### SHEET TITLE: Site Analysis 02






Residential Flat Building 2 Mark St, 1-3 Marsden St Lidcombe, NSW 2141 JOB No.: 8539 DA - D:04

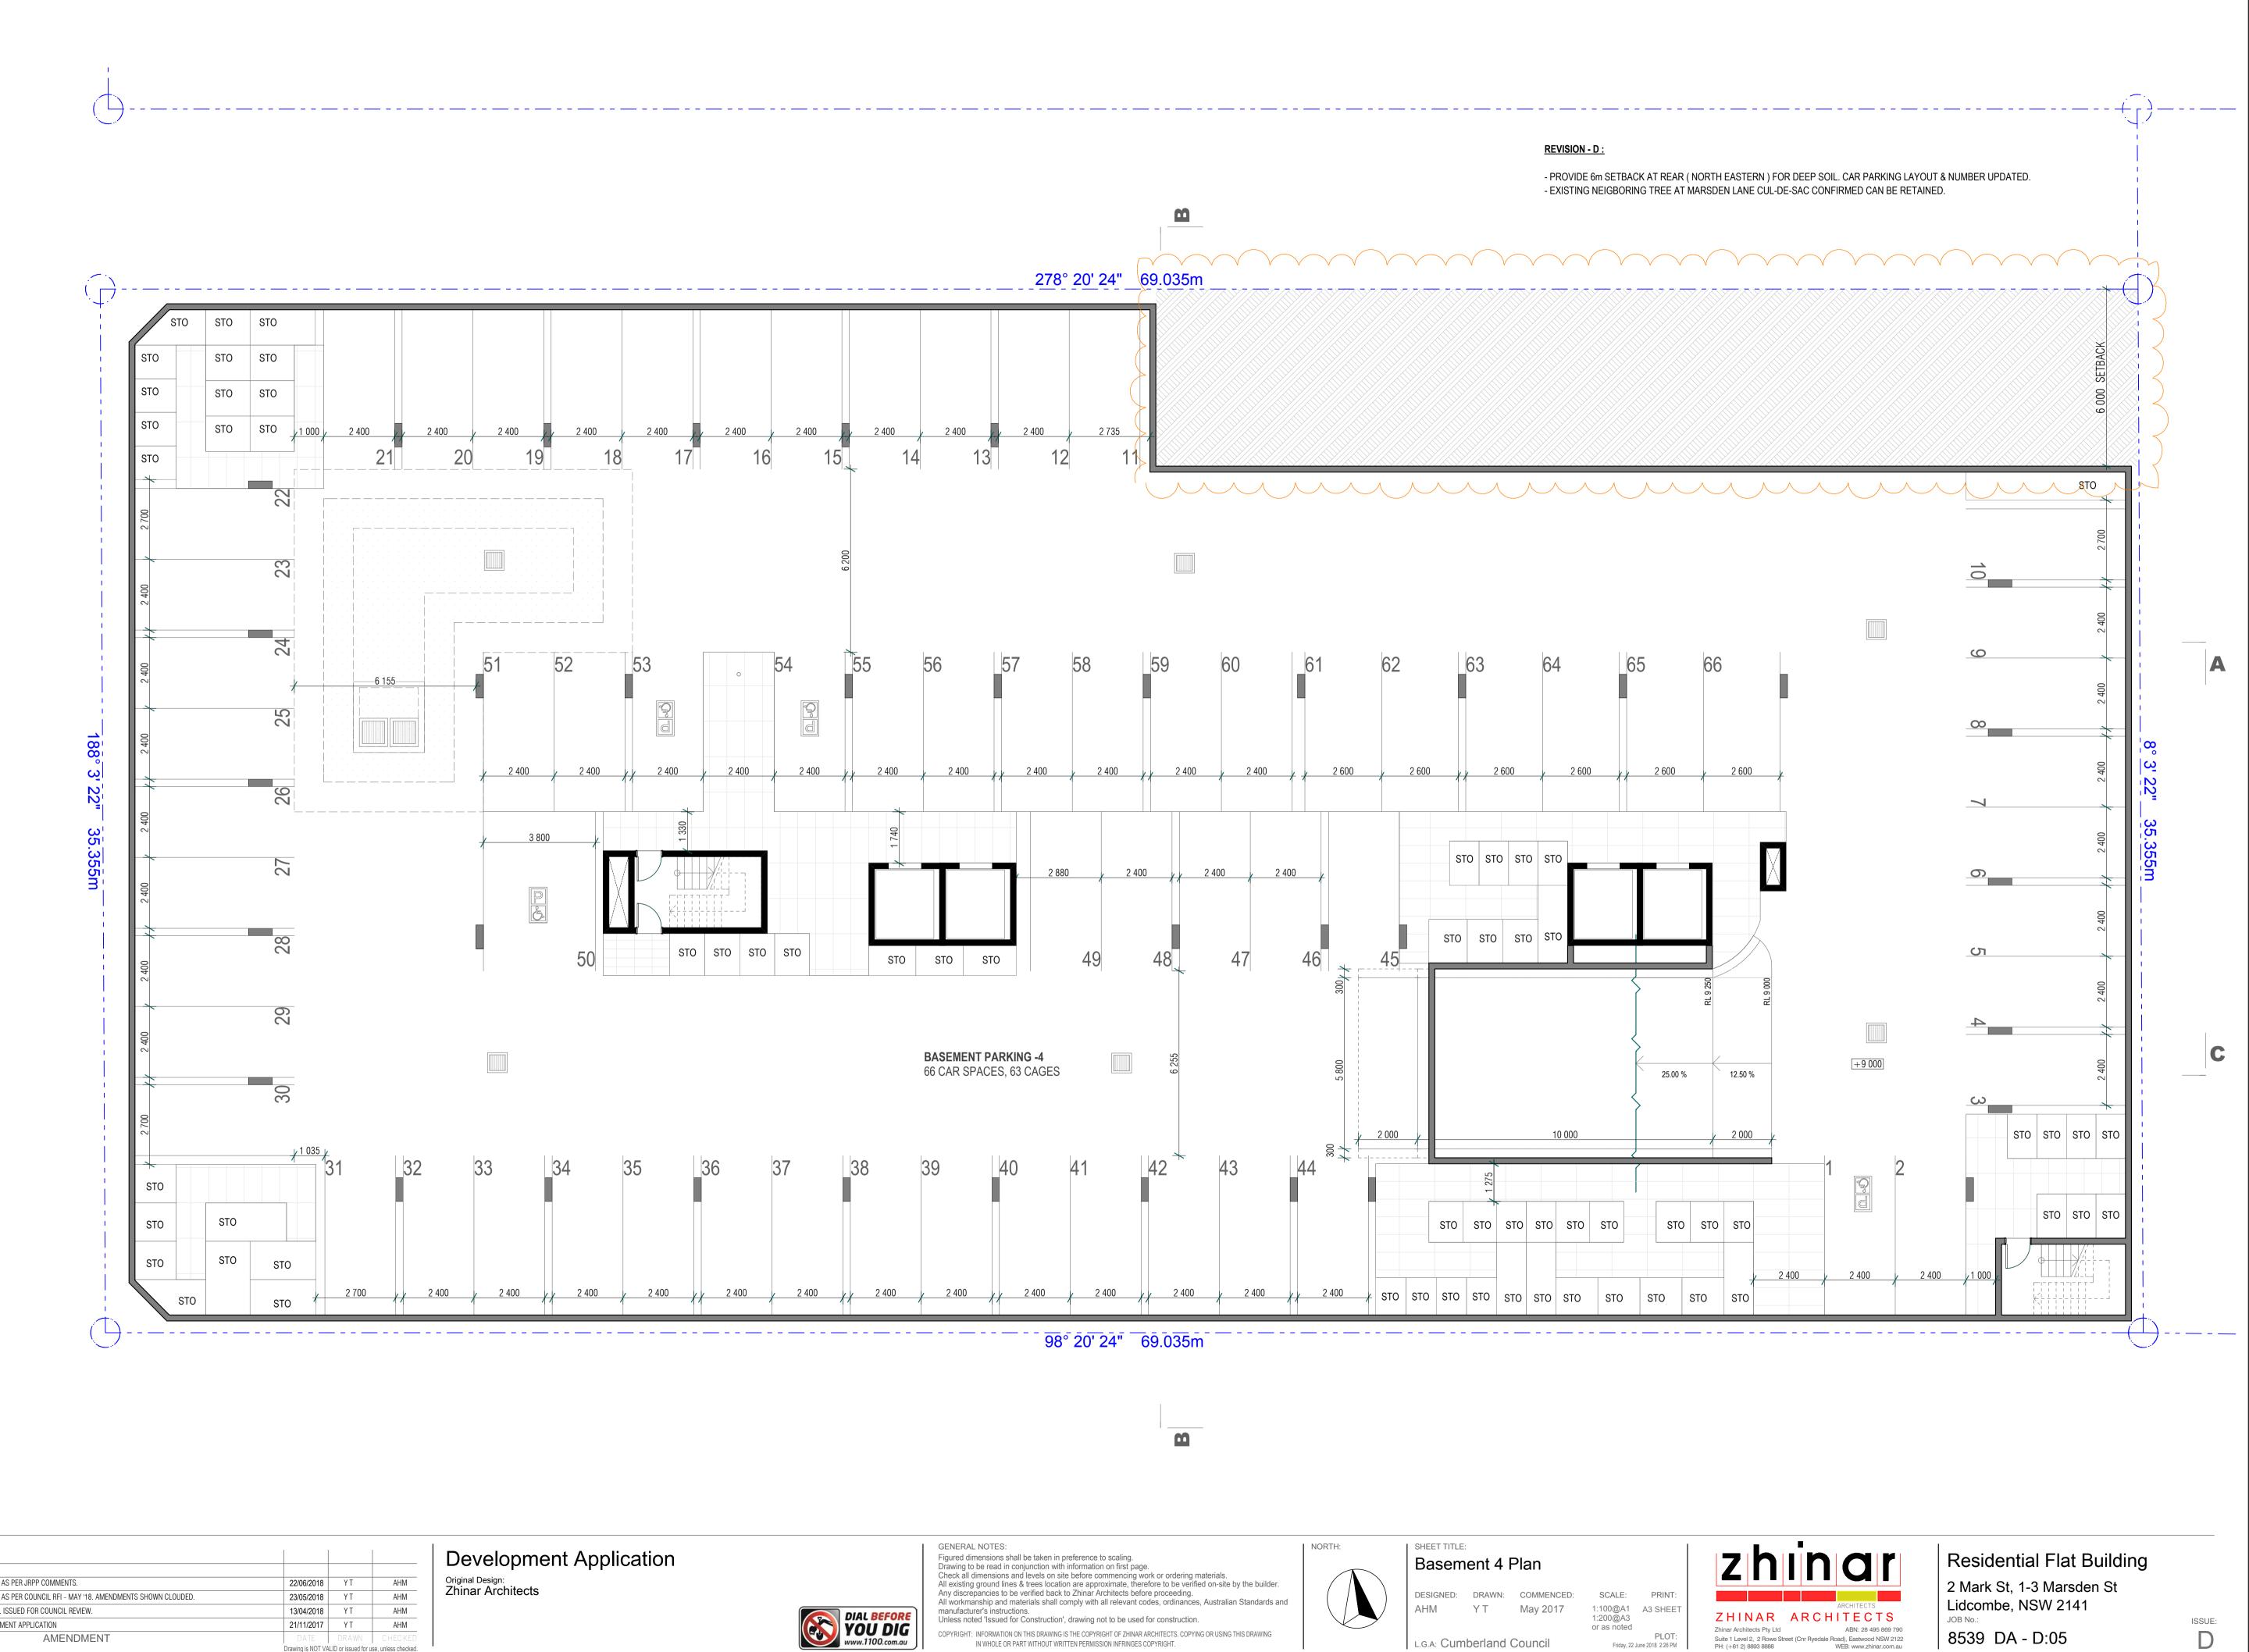


DA-D	DRAWINGS AMENDED AS PER JRPP COMMENTS.	22/06/2018	ΥT	AHM
DA-C	DRAWINGS AMENDED AS PER COUNCIL RFI - MAY '18. AMENDMENTS SHOWN CLOUDED.	23/05/2018	ΥT	AHM
DA-B	DRAWINGS AMENDED. ISSUED FOR COUNCIL REVIEW.	13/04/2018	ΥT	AHM
DA-A	ISSUED FOR DEVELOPMENT APPLICATION	21/11/2017	ΥT	AHM
ISSUE	AMENDMENT	DATE	DRAWN	CHECKED
		Drawing is NOT VA	LID or issued for u	se. unless checked.

С

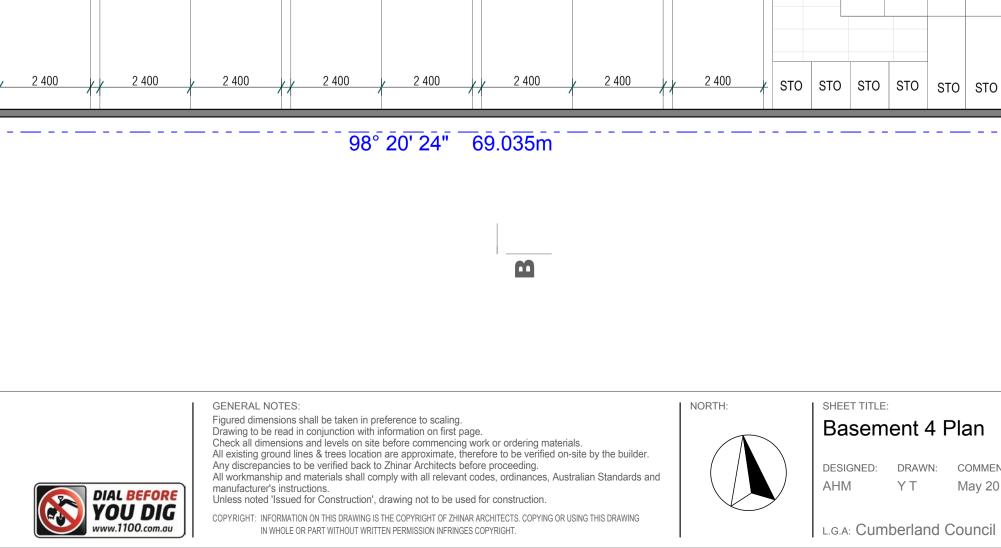


Friday, 22 June 2018 2:26 PM

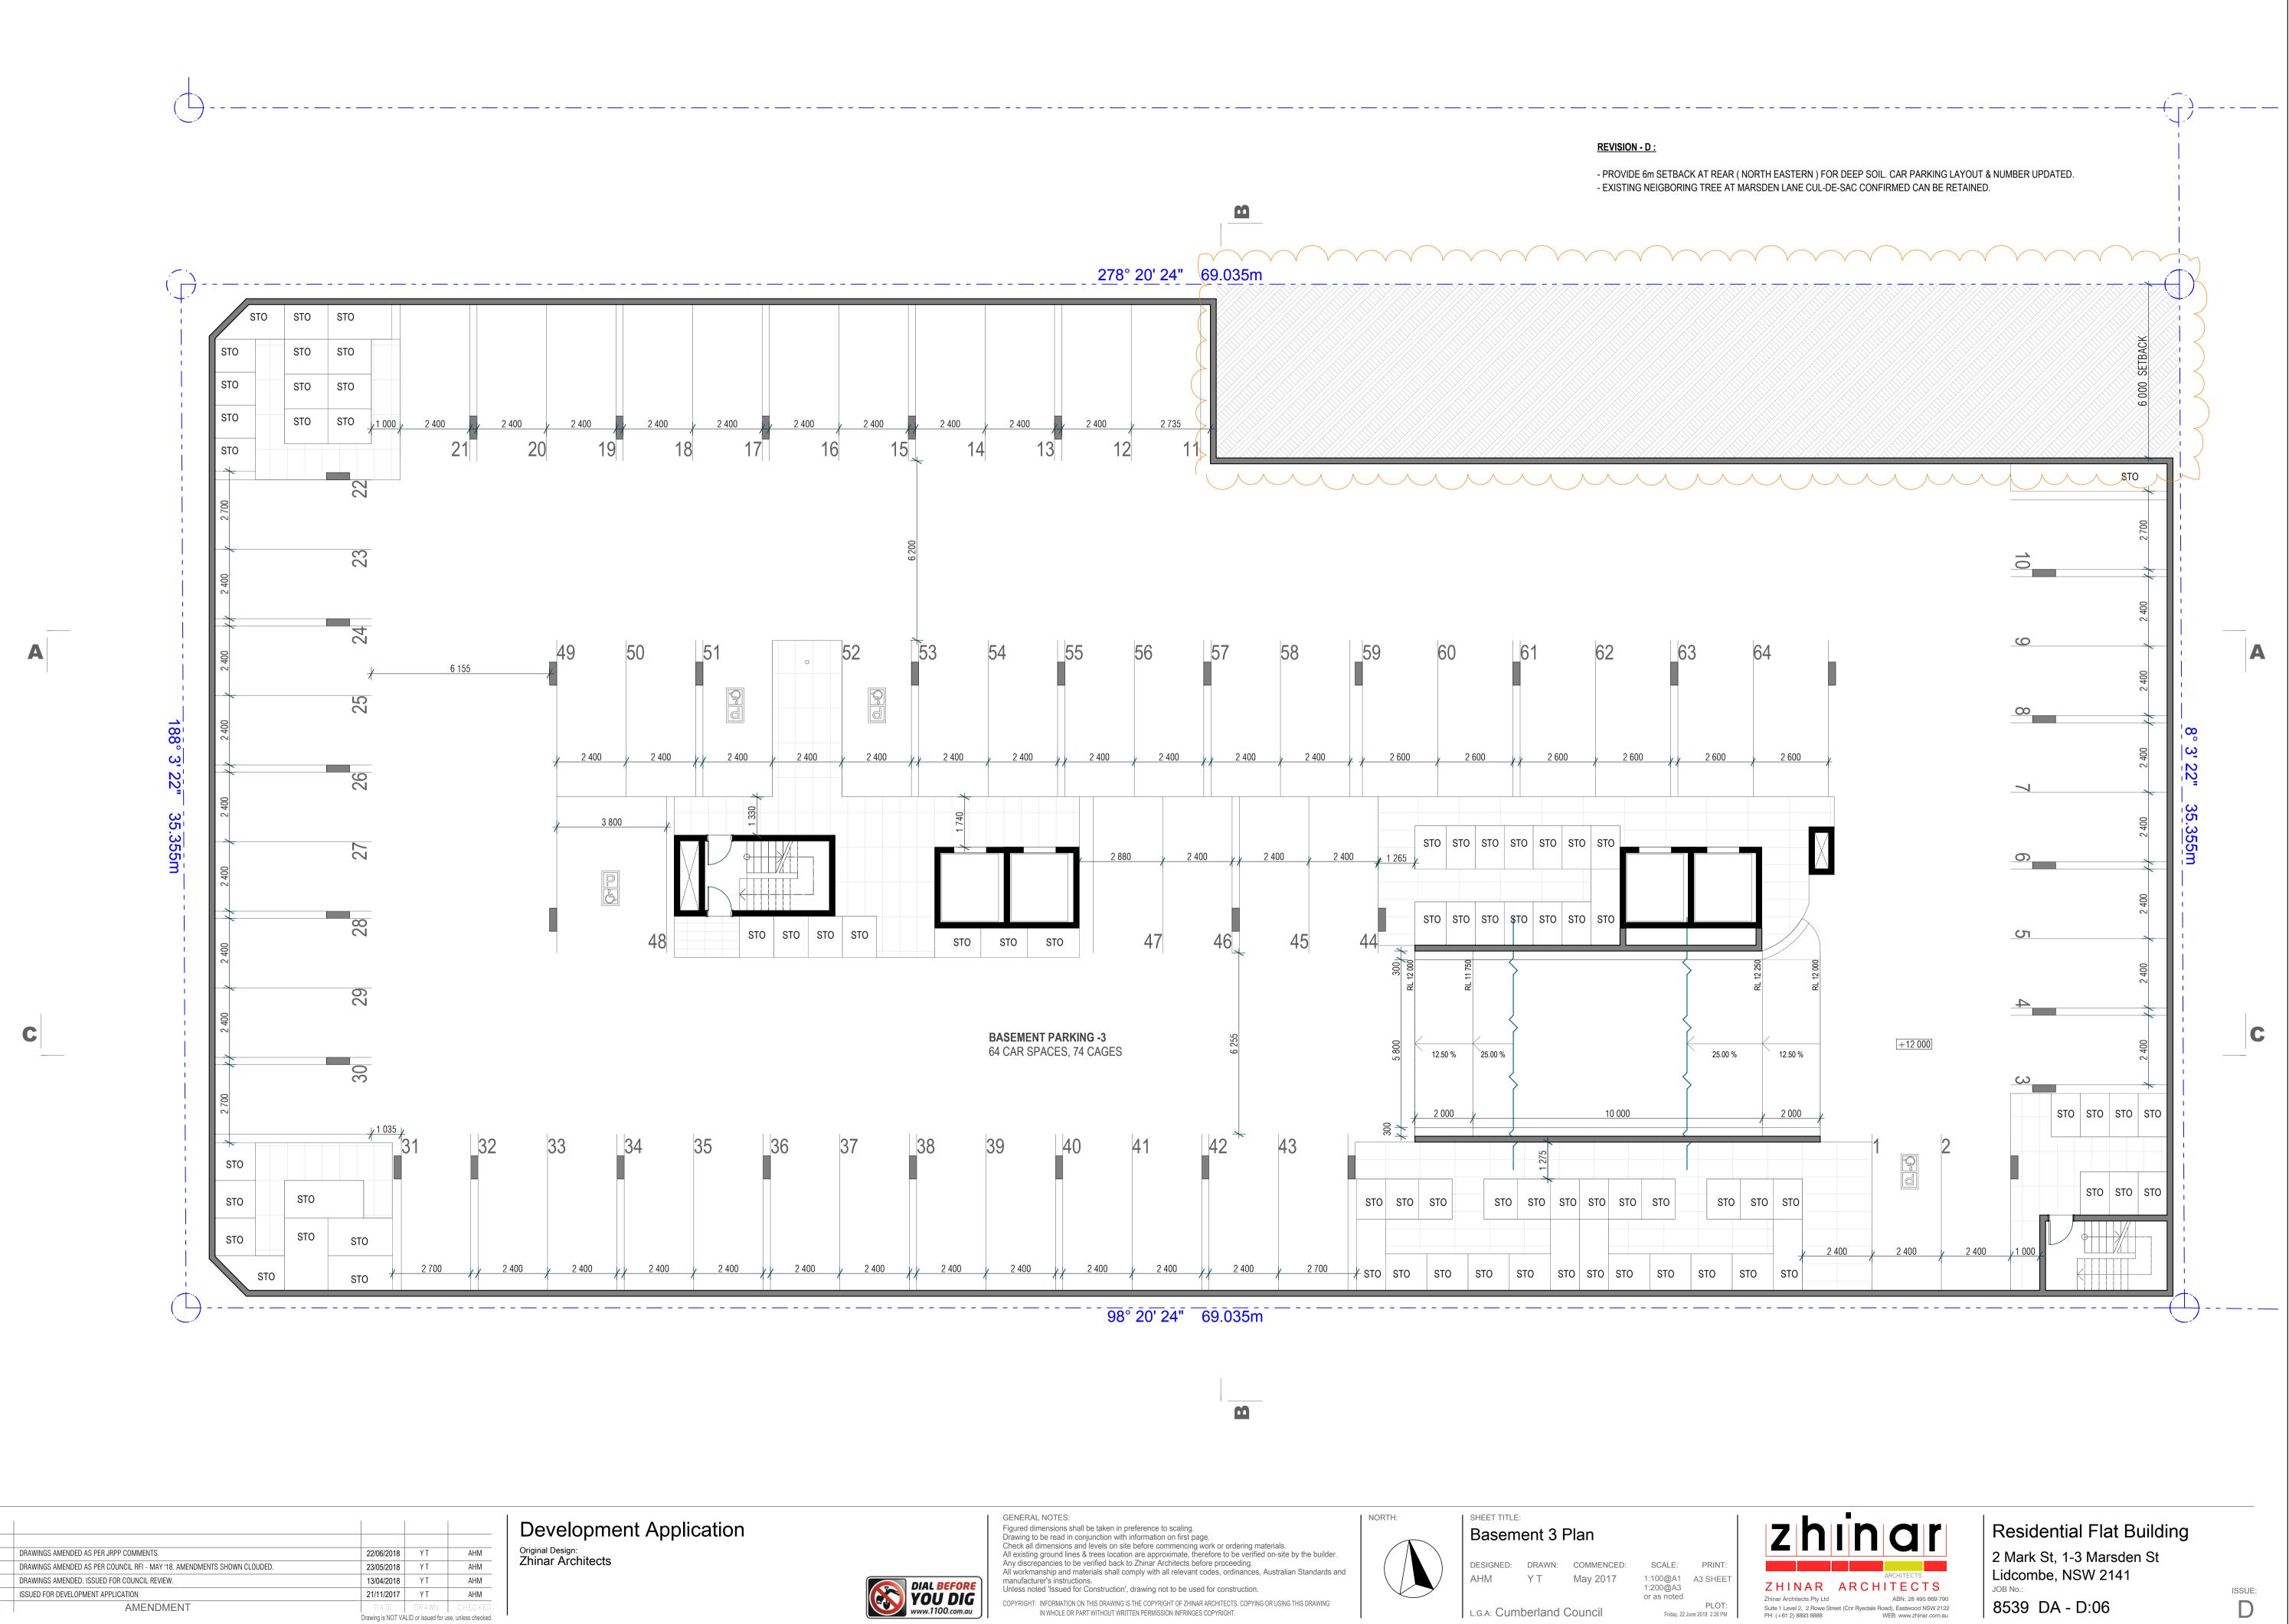


DA-D	DRAWINGS AMENDED AS PER JRPP COMMENTS.	22/06/2018	ΥT	AHM
DA-C	DRAWINGS AMENDED AS PER COUNCIL RFI - MAY '18. AMENDMENTS SHOWN CLOUDED.	23/05/2018	ΥT	AHM
DA-B	DRAWINGS AMENDED. ISSUED FOR COUNCIL REVIEW.	13/04/2018	ΥT	AHM
DA-A	ISSUED FOR DEVELOPMENT APPLICATION	21/11/2017	ΥT	AHM
ISSUE	AMENDMENT	DATE	DRAWN	CHECKED
		Drawing is NOT VA	ALID or issued for u	se, unless checked.



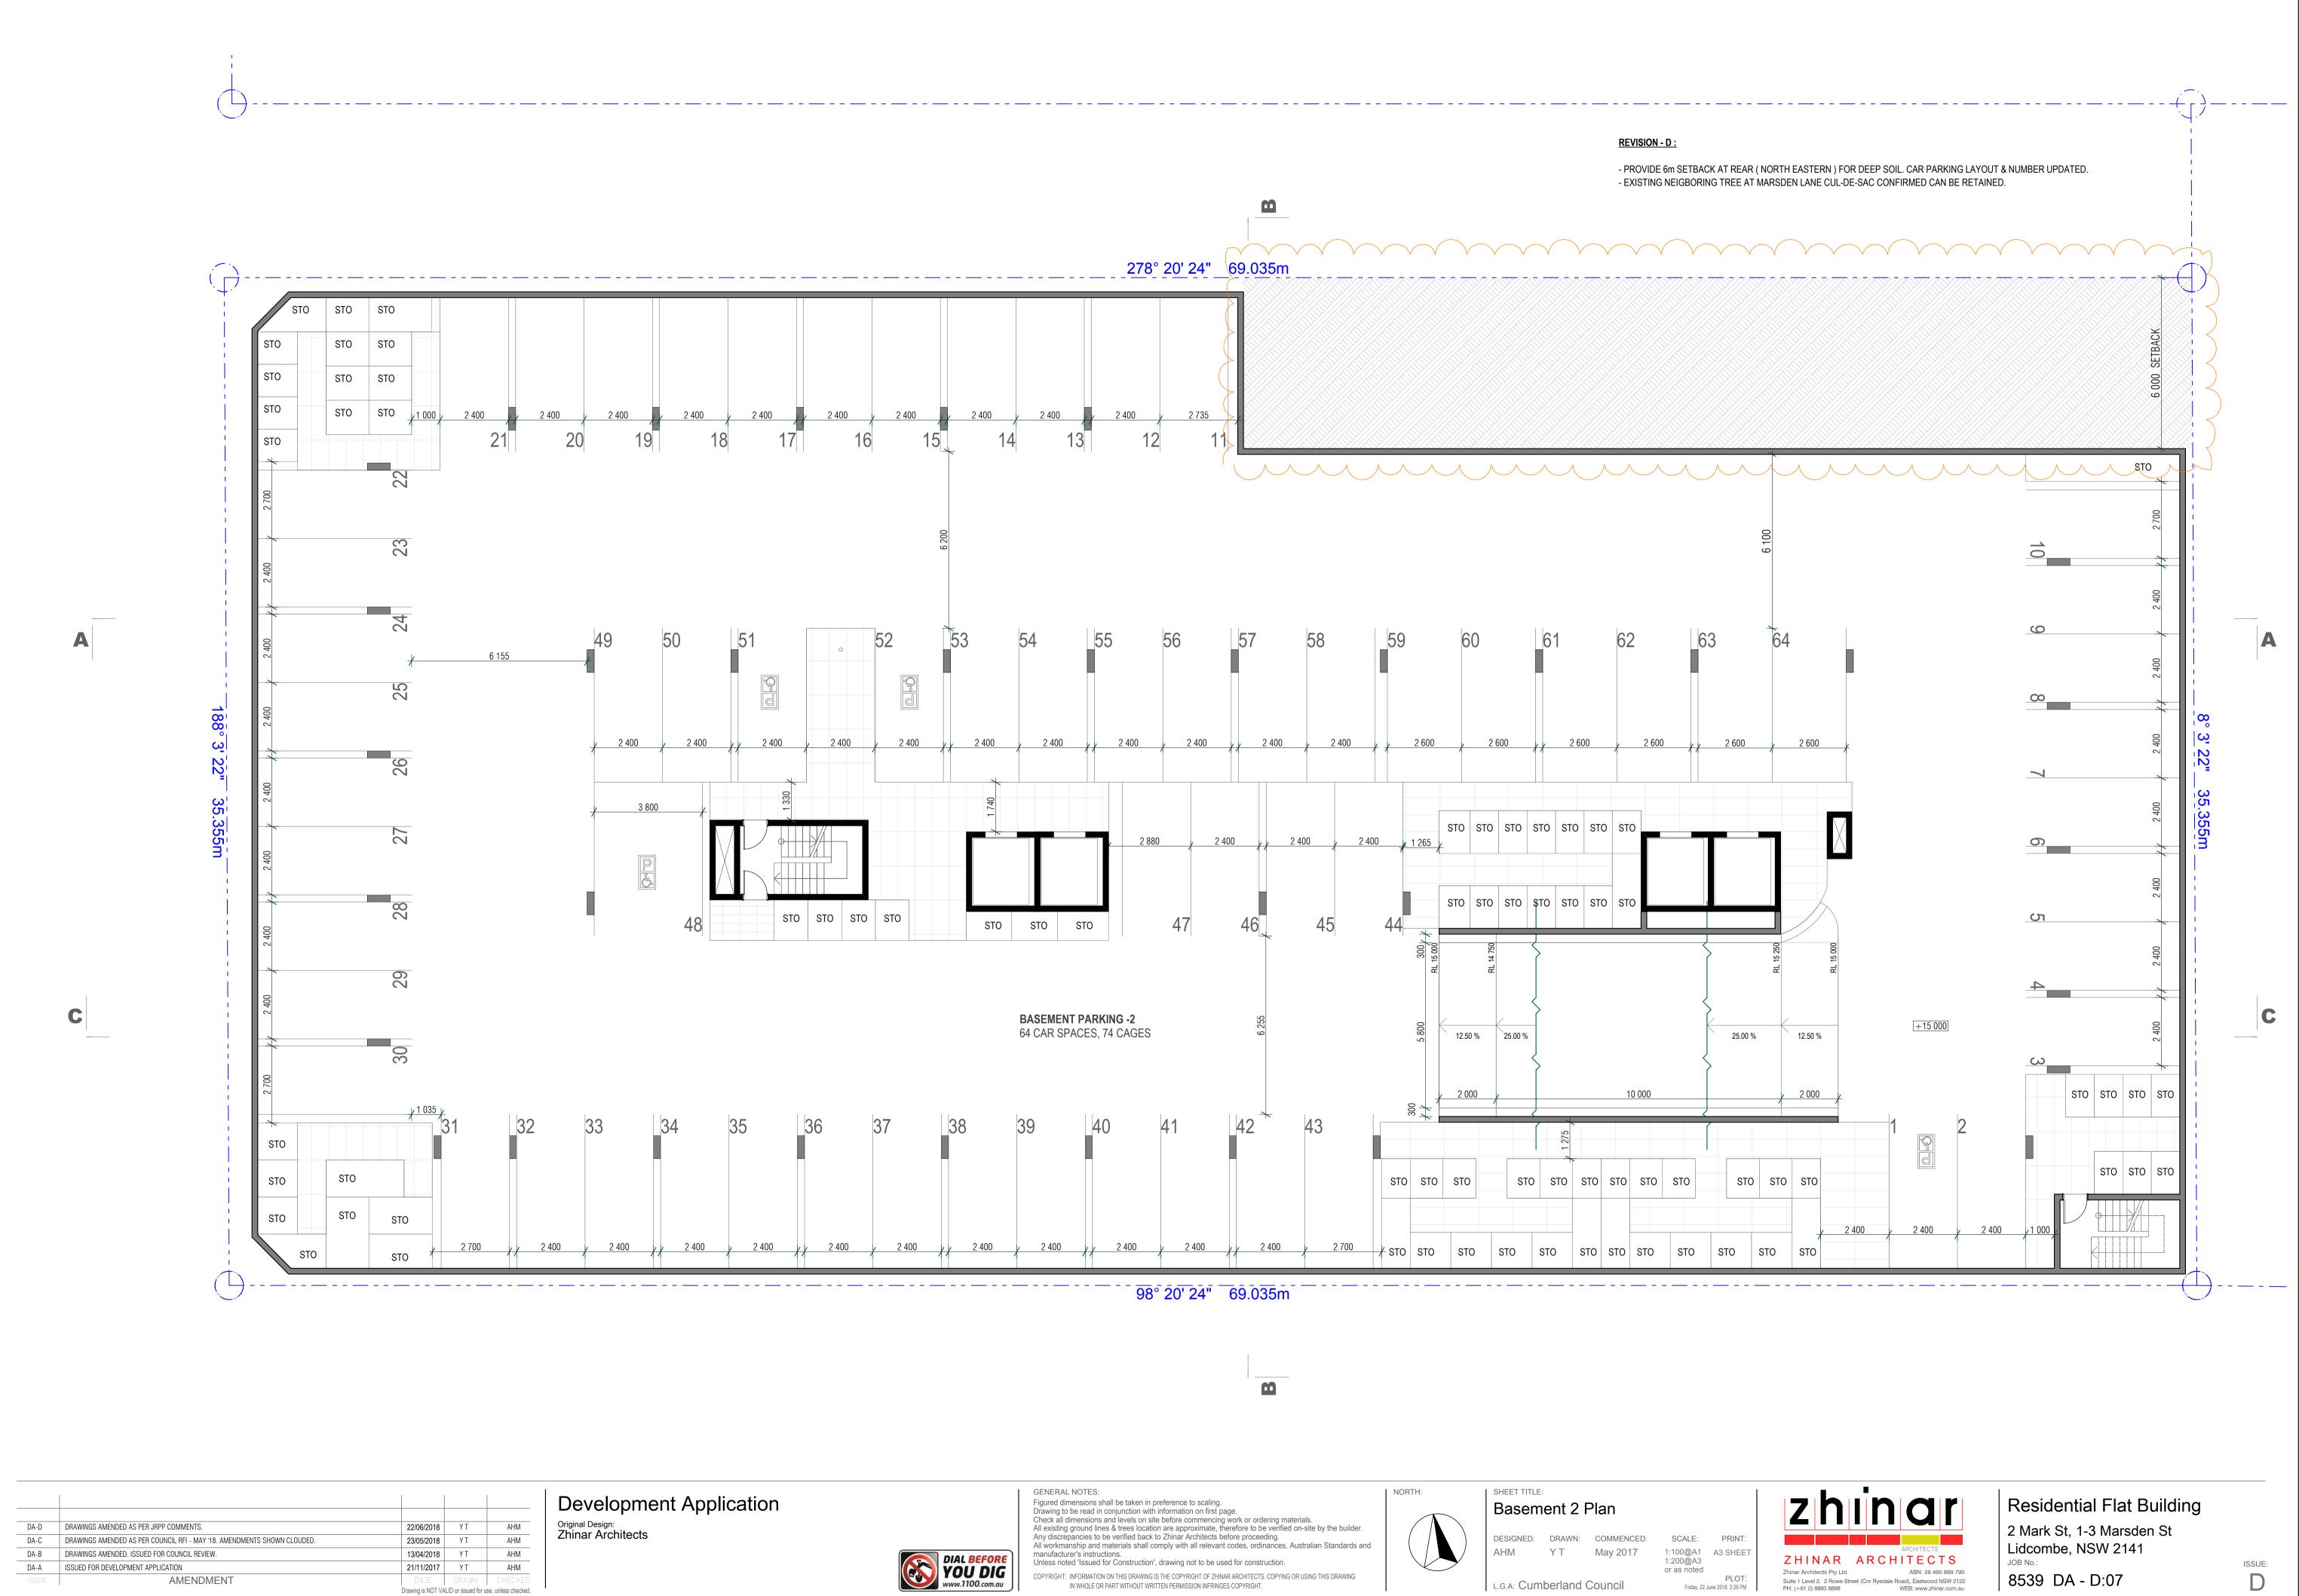


A-D	DRAWINGS AMENDED AS PER JRPP COMMENTS.	22/06/2018	ΥT	A
A-C	DRAWINGS AMENDED AS PER COUNCIL RFI - MAY '18. AMENDMENTS SHOWN CLOUDED.	23/05/2018	ΥT	A
A-B	DRAWINGS AMENDED. ISSUED FOR COUNCIL REVIEW.	13/04/2018	ΥT	A
A-A	ISSUED FOR DEVELOPMENT APPLICATION	21/11/2017	ΥT	A
SUE	AMENDMENT	DATE	DRAWN	CHE



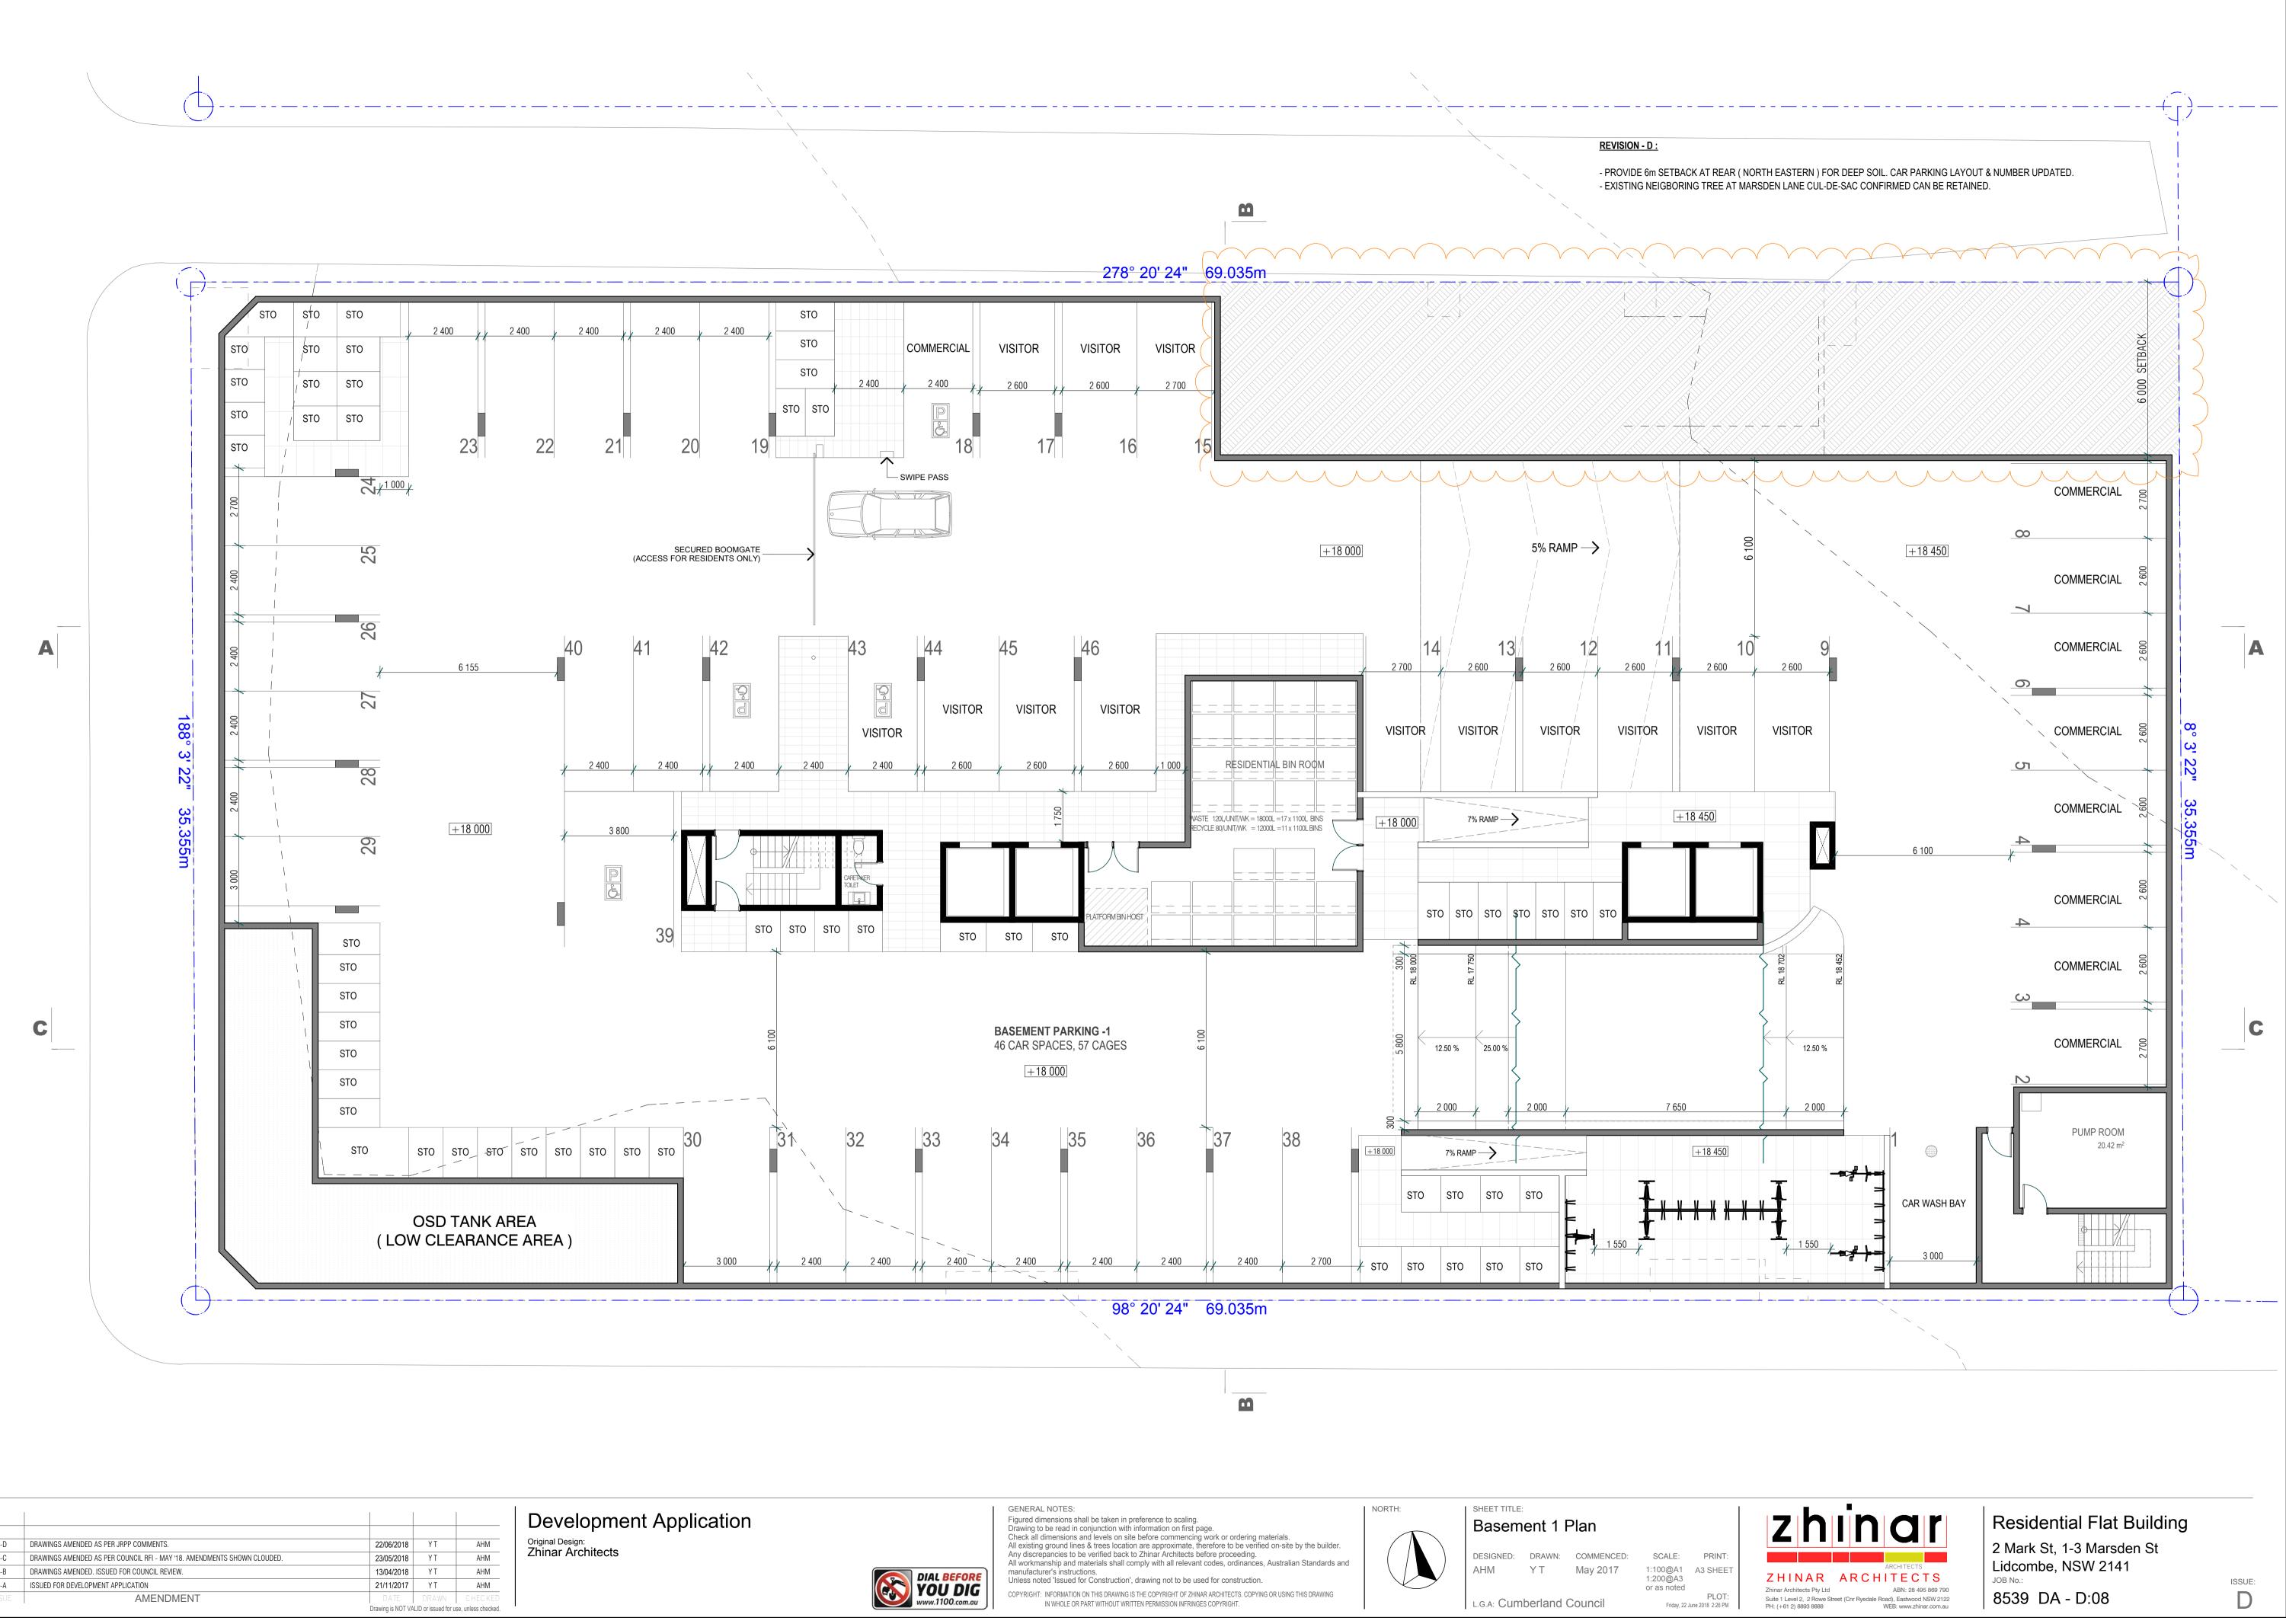

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DA-D	DRAWINGS AMENDED AS PER JRPP COMMENTS.	22/06/2018	ΥT	AHM
DA-C	DRAWINGS AMENDED AS PER COUNCIL RFI - MAY '18. AMENDMENTS SHOWN CLOUDED.	23/05/2018	ΥT	AHM
DA-B	DRAWINGS AMENDED. ISSUED FOR COUNCIL REVIEW.	13/04/2018	ΥT	AHM
DA-A	ISSUED FOR DEVELOPMENT APPLICATION	21/11/2017	ΥT	AHM
ISSUE	AMENDMENT	DATE	DRAWN	CHECKED
		Drawing is NOT VA	ALID or issued for u	se, unless checked.

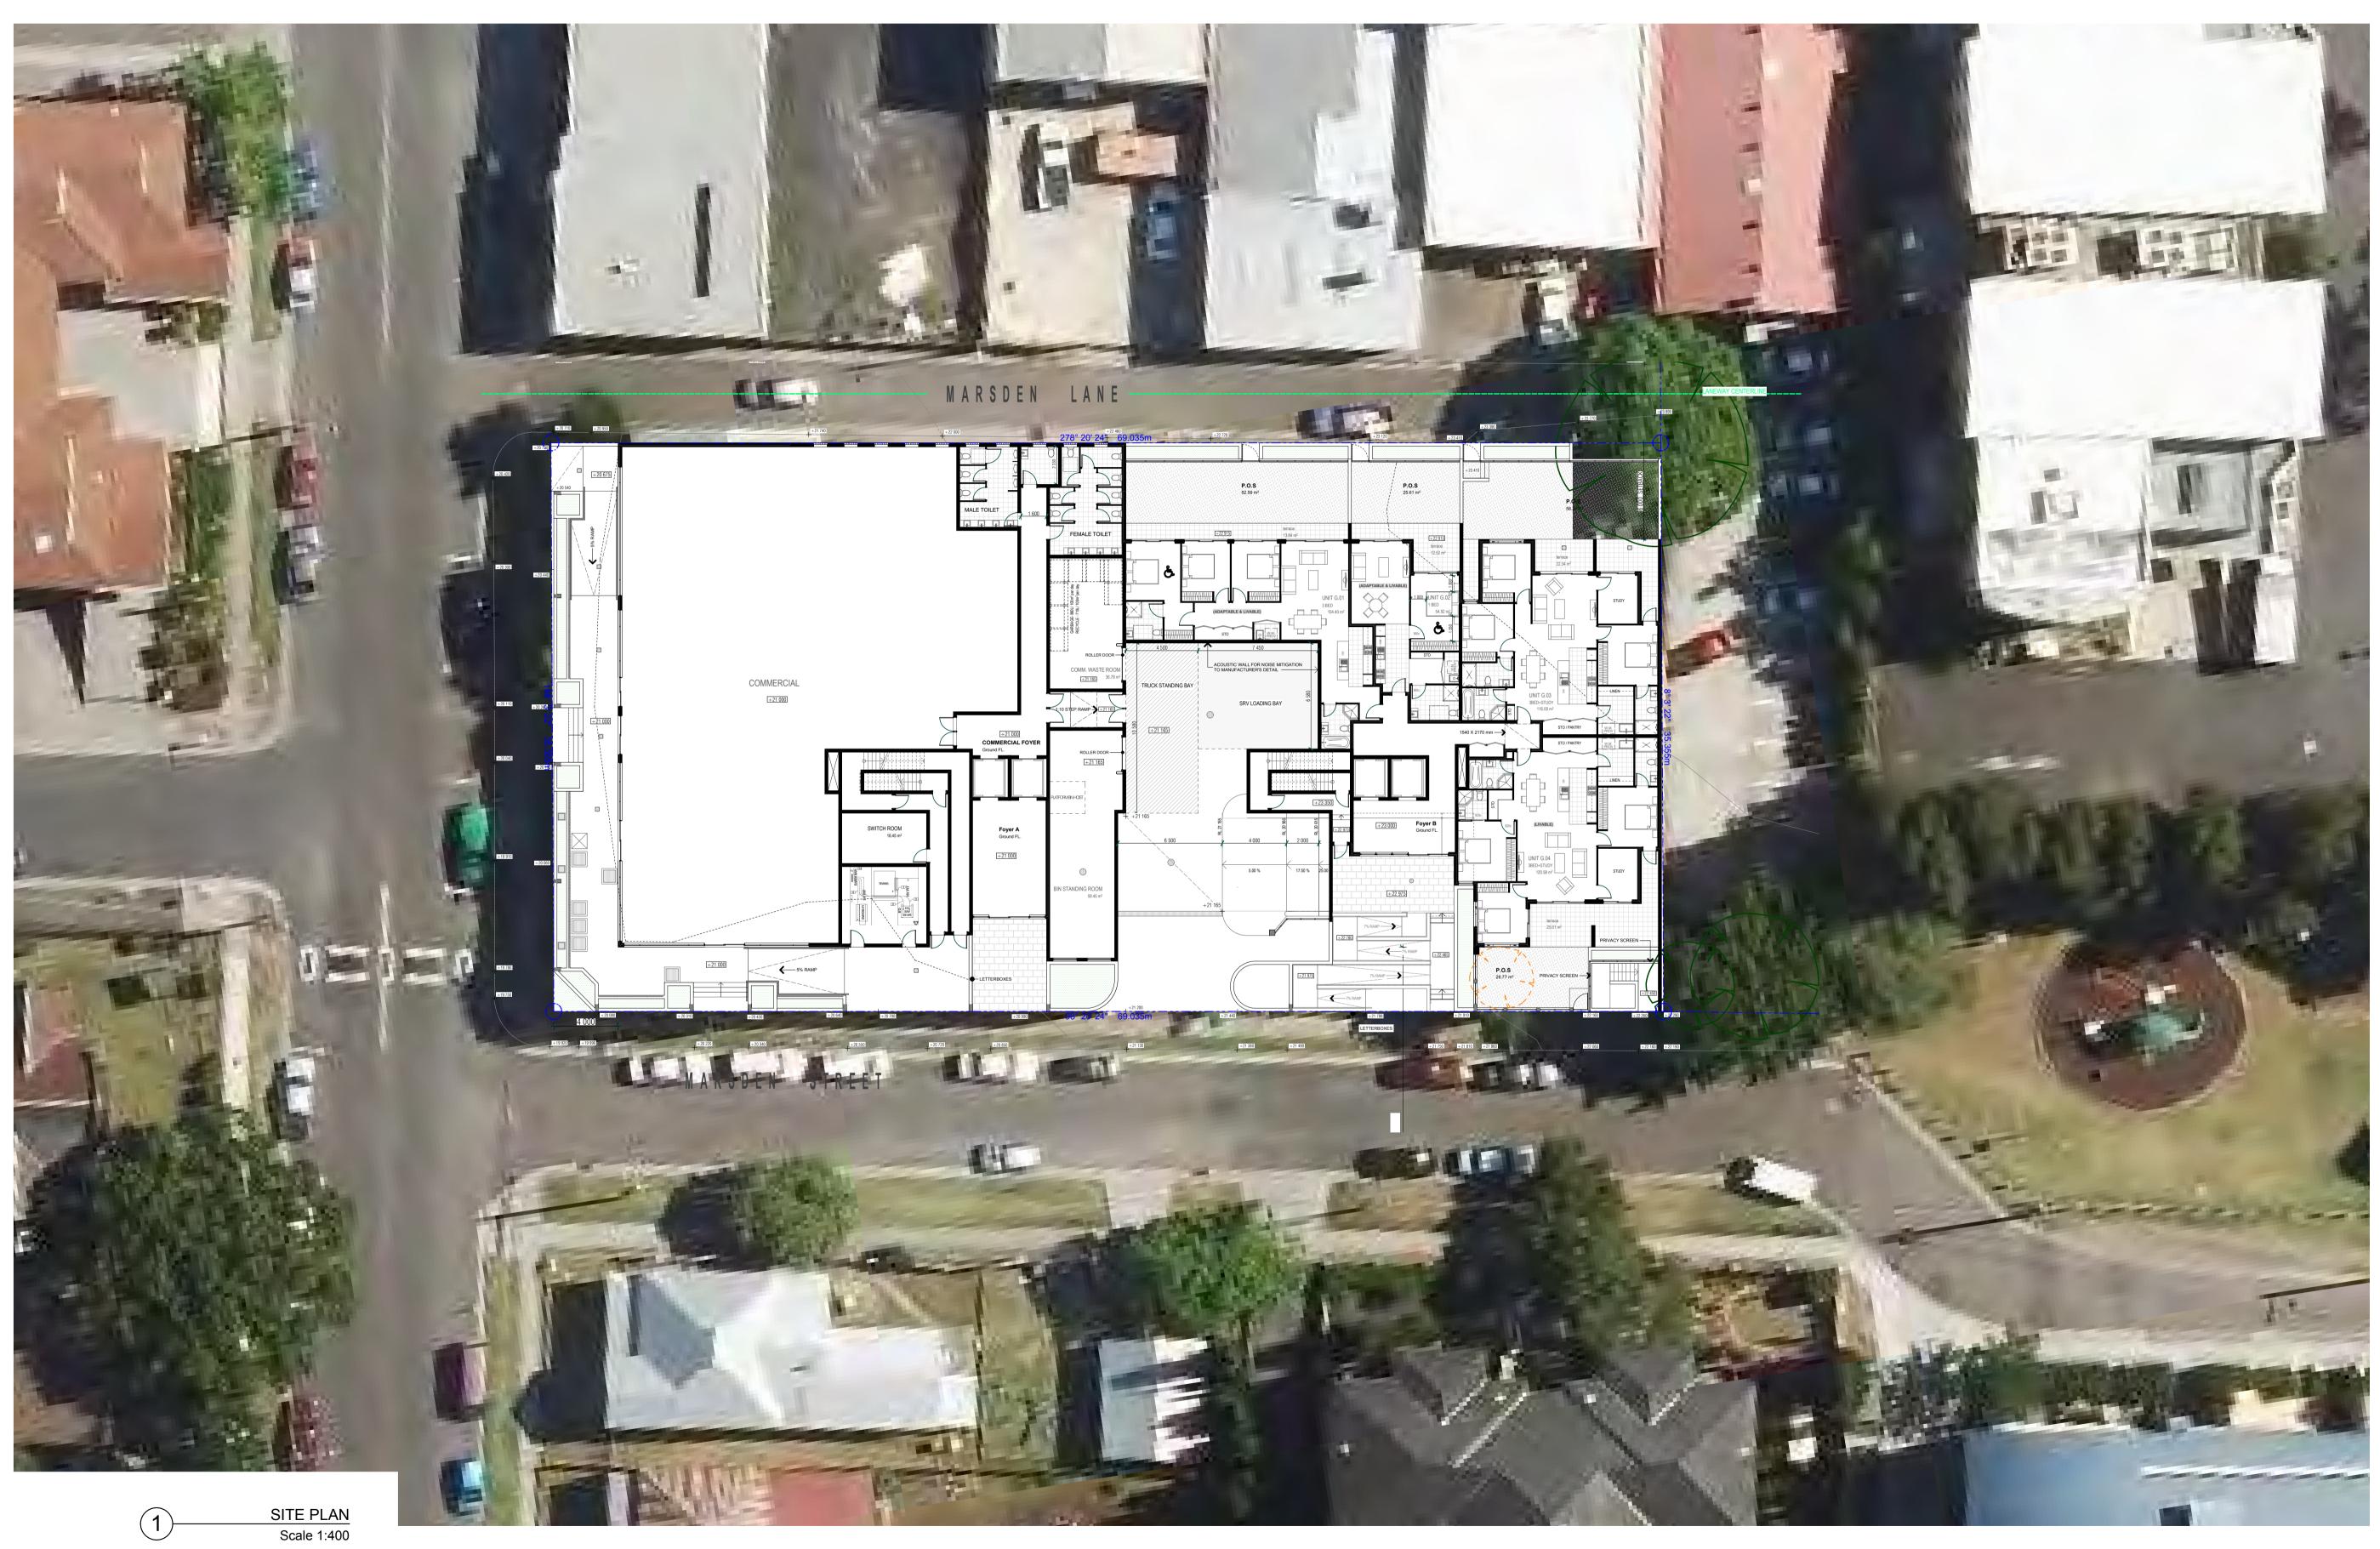


1	SITE PLAN
<u> </u>	Scale 1:400

DA-D	DRAWINGS AMENDED AS PER JRPP COMMENTS.	27/06/2018	ΥT	AHM
DA-C	DRAWINGS AMENDED AS PER COUNCIL RFI - MAY '18. AMENDMENTS SHOWN CLOUDED.	23/05/2018	ΥT	AHM
DA-B	DRAWINGS AMENDED. ISSUED FOR COUNCIL REVIEW.	13/04/2018	ΥT	AHM
DA-A	ISSUED FOR DEVELOPMENT APPLICATION	21/11/2017	ΥT	AHM
ISSUE	AMENDMENT	DATE	DRAWN	CHECKED
Drawing is NOT VALID or issued for use, unless checked.				

**Development Application** Original Design: Zhinar Architects



GENERAL NOTES: Figured dimensions shall be taken in preference to scaling. Drawing to be read in conjunction with information on first page. Check all dimensions and levels on site before commencing work or ordering materials. All existing ground lines & trees location are approximate, therefore to be verified on-site by the builder. Any discrepancies to be verified back to Zhinar Architects before proceeding. All workmanship and materials shall comply with all relevant codes, ordinances, Australian Standards and manufacturer's instructions. Unless noted 'Issued for Construction', drawing not to be used for construction. COPYRIGHT: INFORMATION ON THIS DRAWING IS THE COPYRIGHT OF ZHINAR ARCHITECTS. COPYING OR USING THIS DRAWING IN WHOLE OR PART WITHOUT WRITTEN PERMISSION INFRINGES COPYRIGHT.

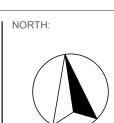

## SHEET TITLE: Site Plan


DESIGNED: DRAWN: COMMENCED: AHM YT May 2017


L.G.A: Cumberland Council


SCALE: PRINT: 1:100@A1 A3 SHEET 1:200@A3 or as noted PLOT: Wednesday, 27 June 2018 3:32 PM





Residential Flat Building 1:150@A1 1:300@A3 2 Mark St, 1-3 Marsden St Lidcombe, NSW 2141 JOB No.: 8539 DA - D:09

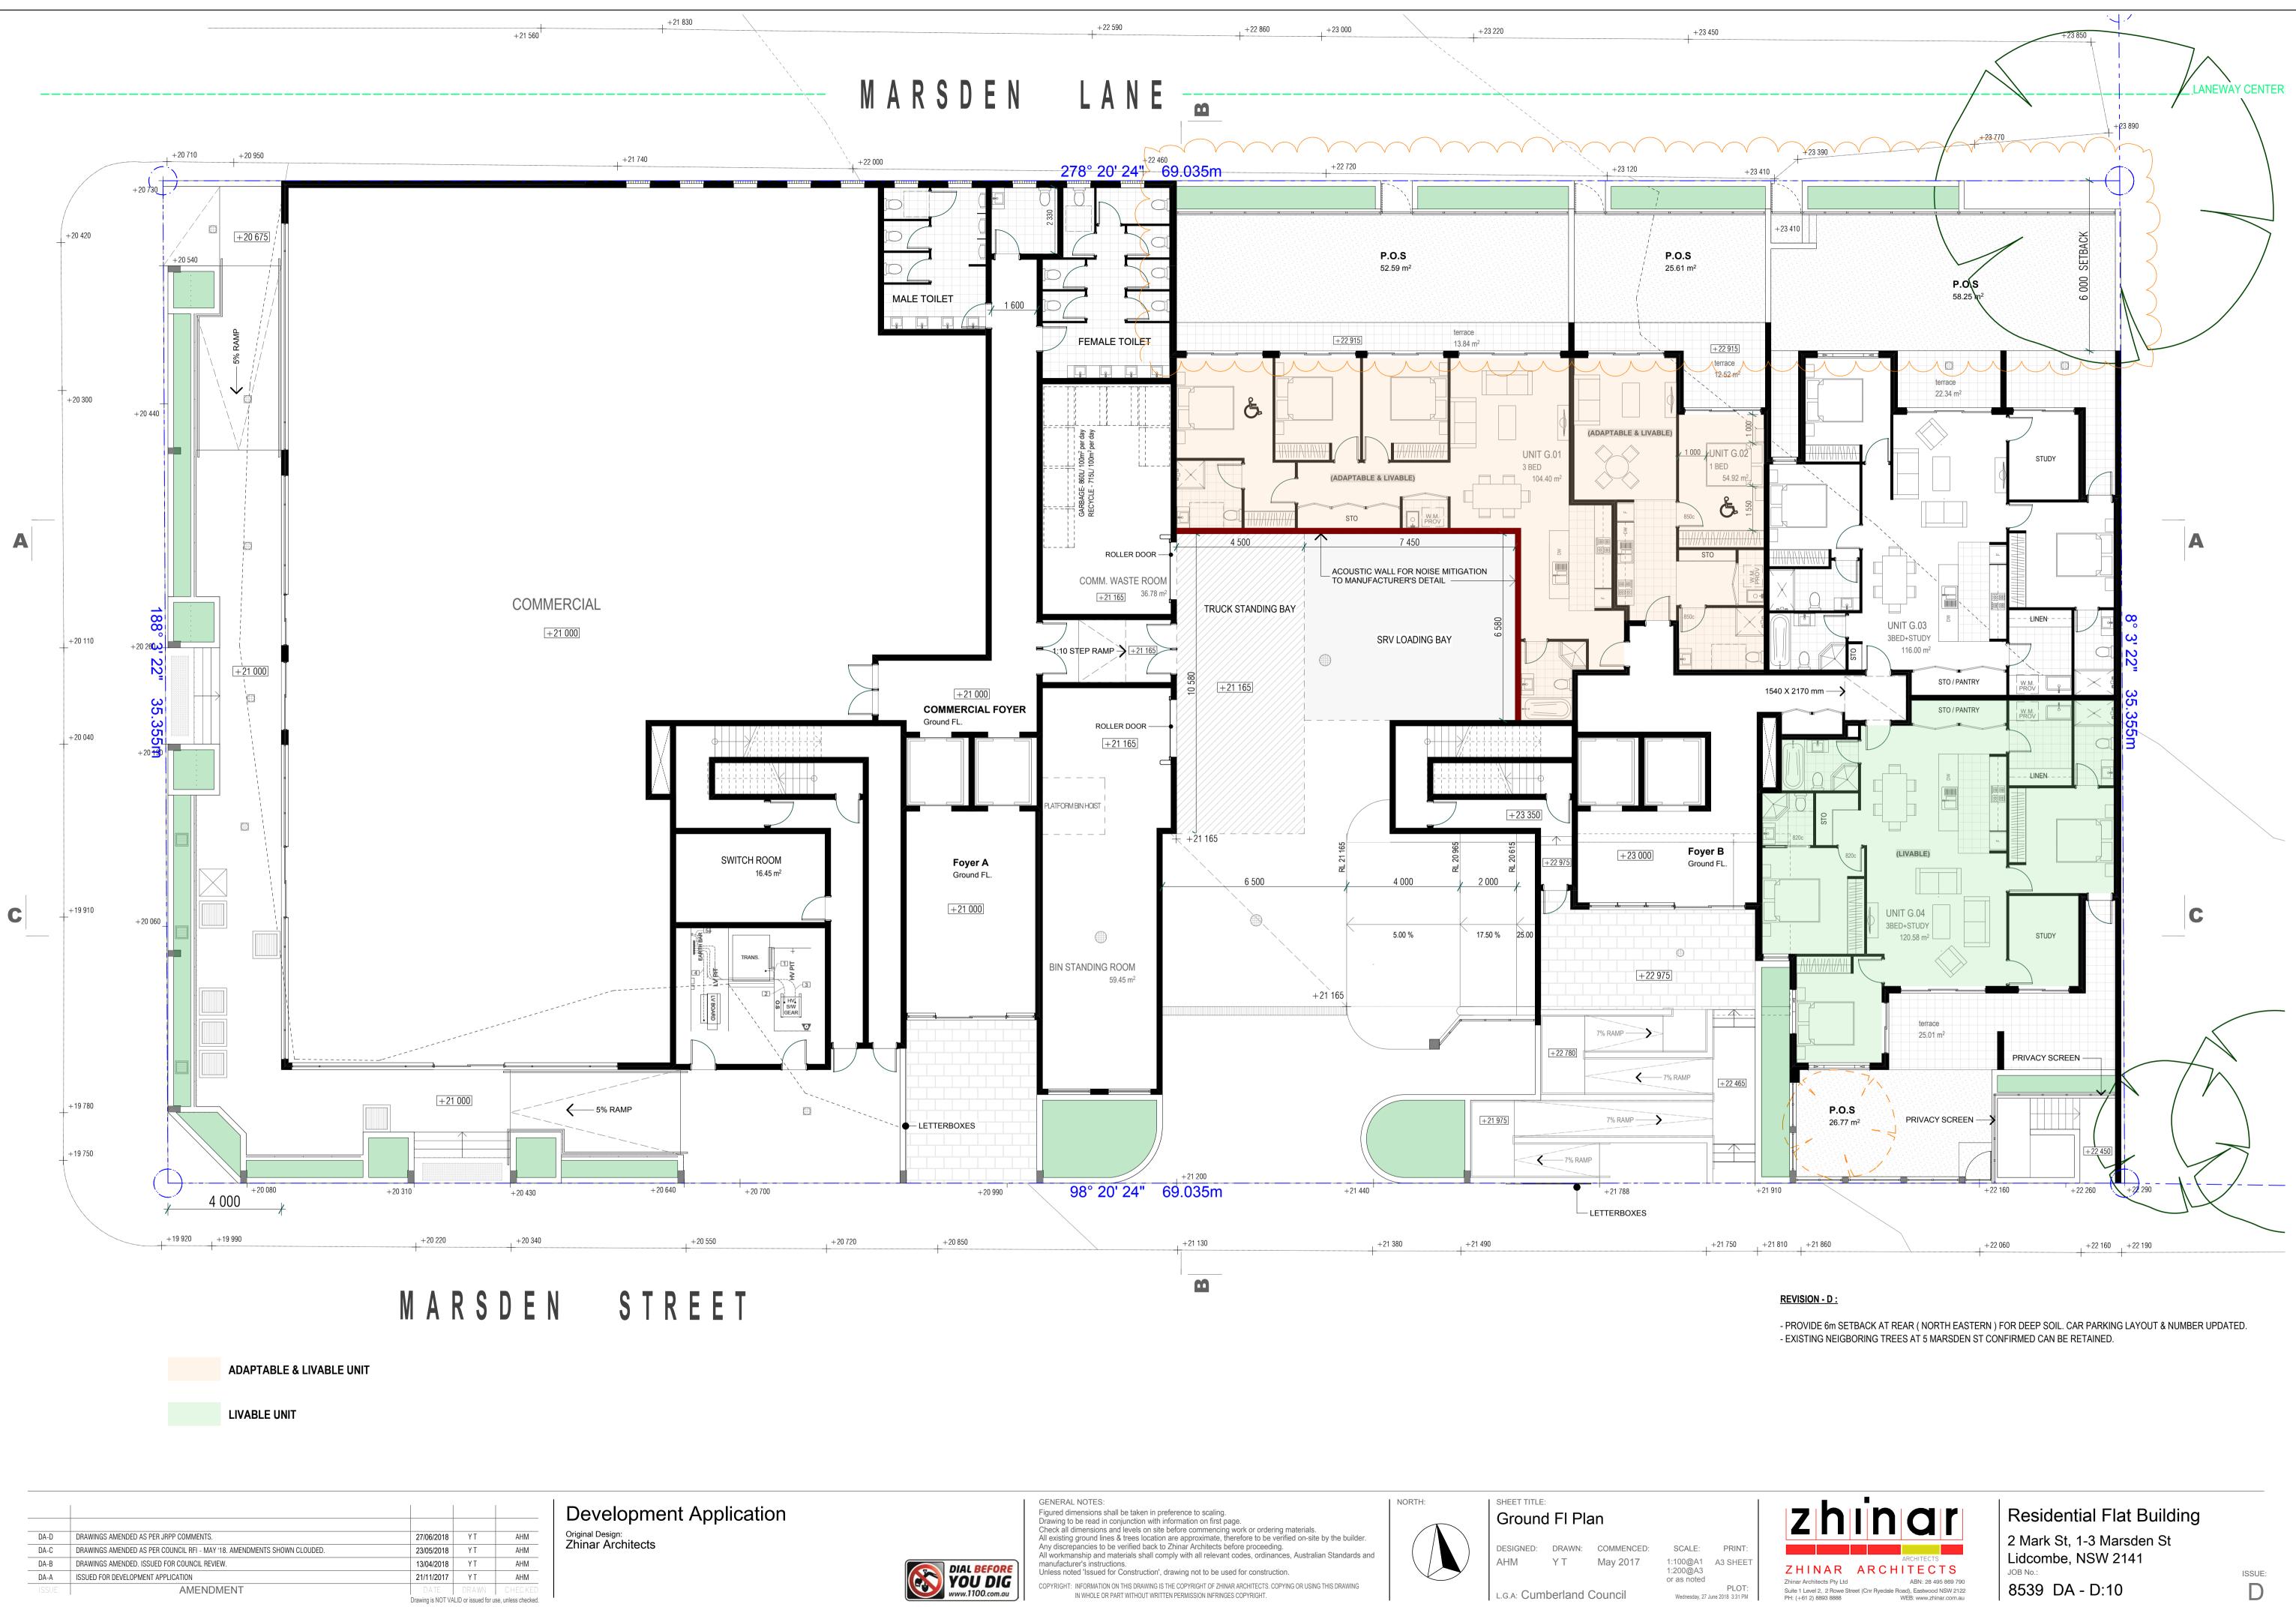


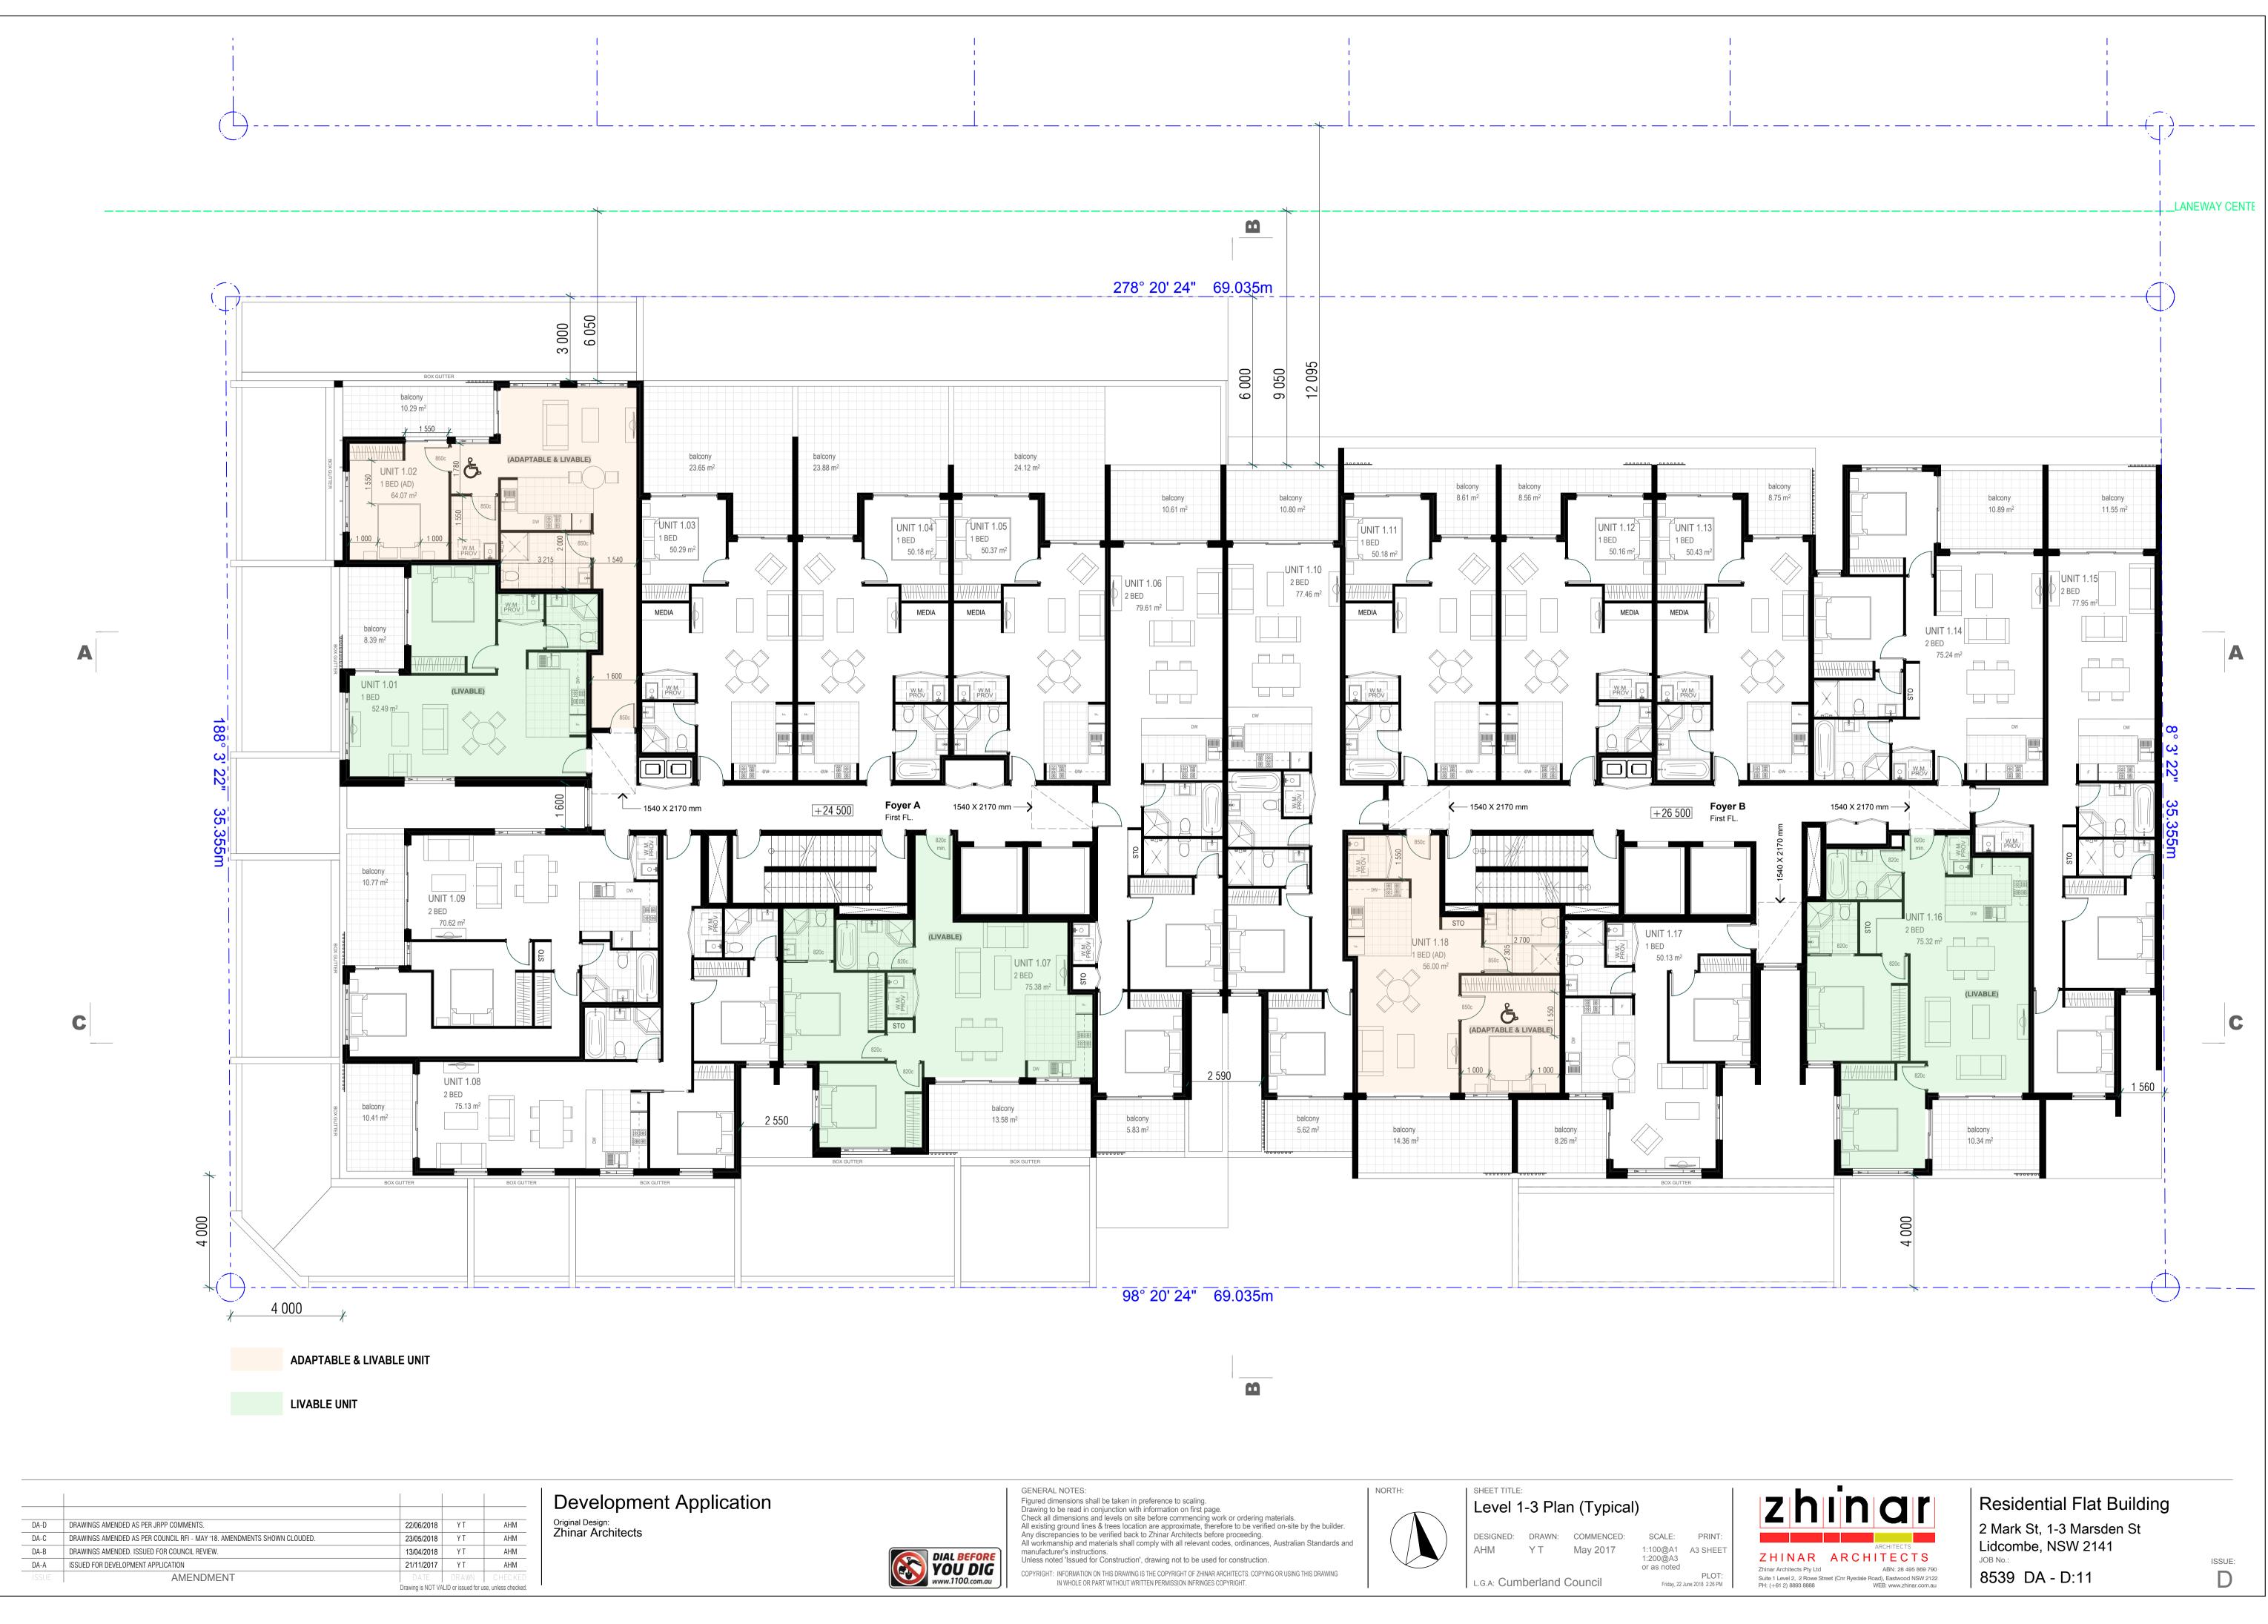


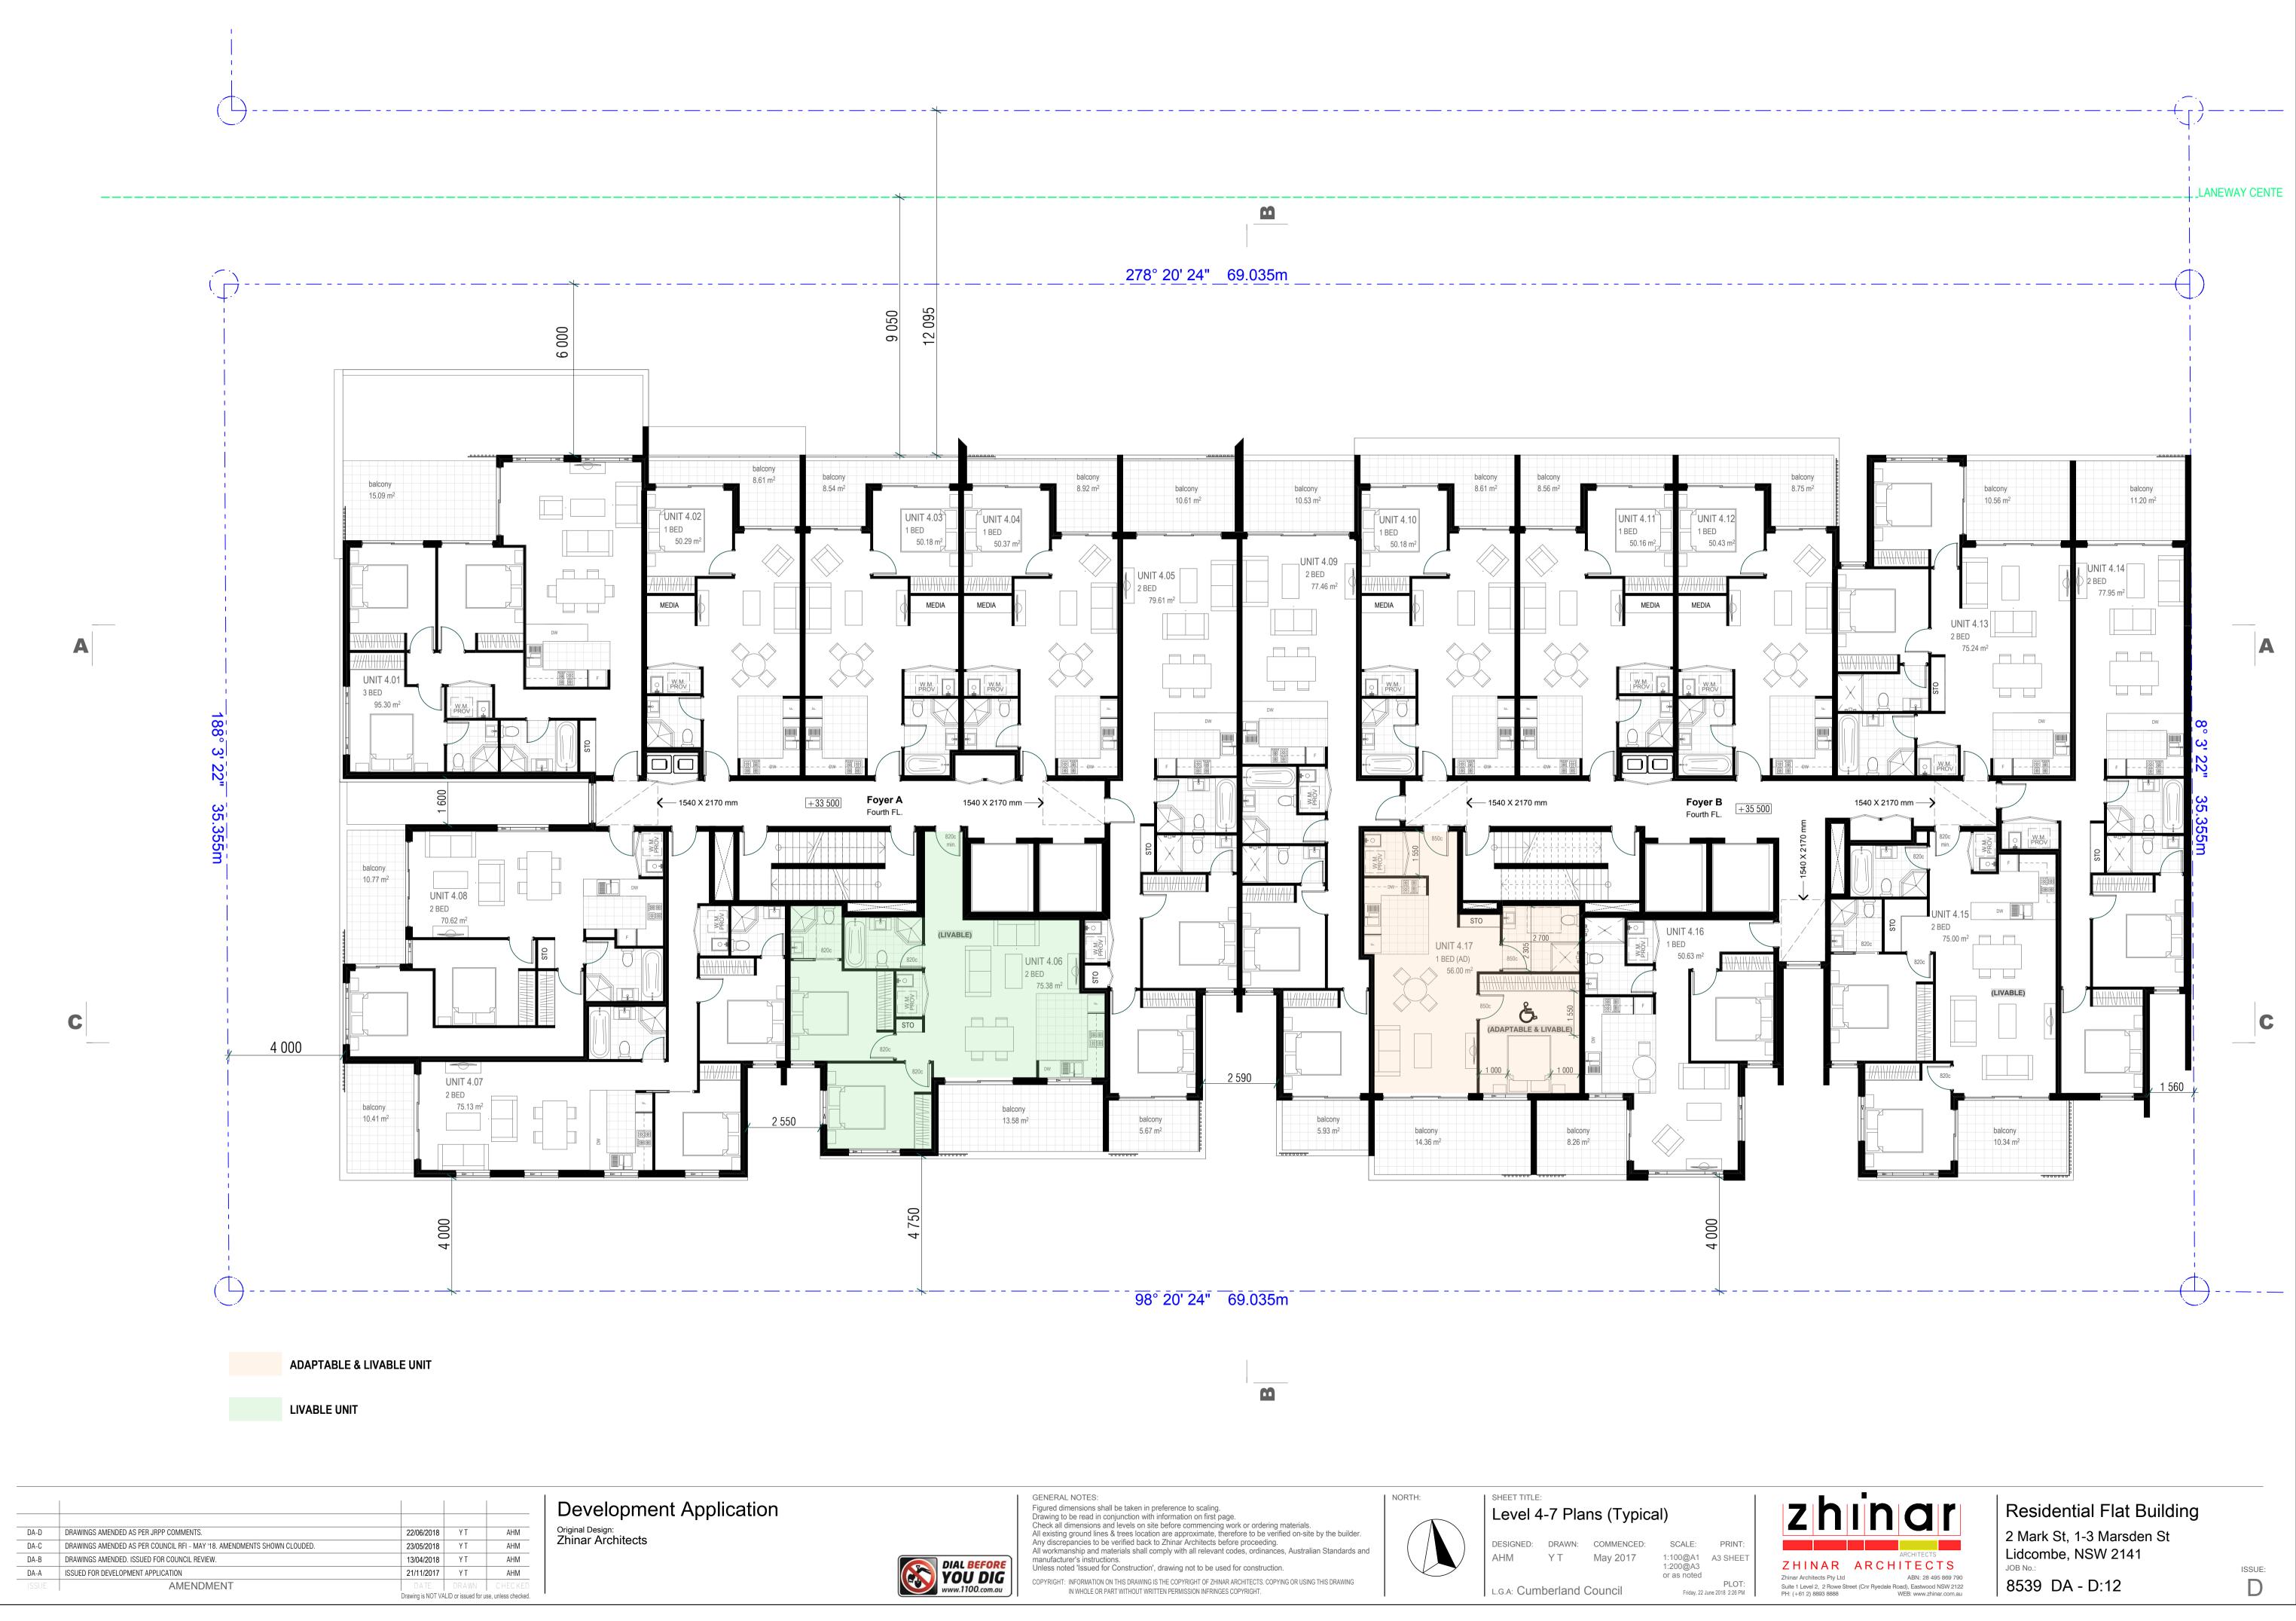

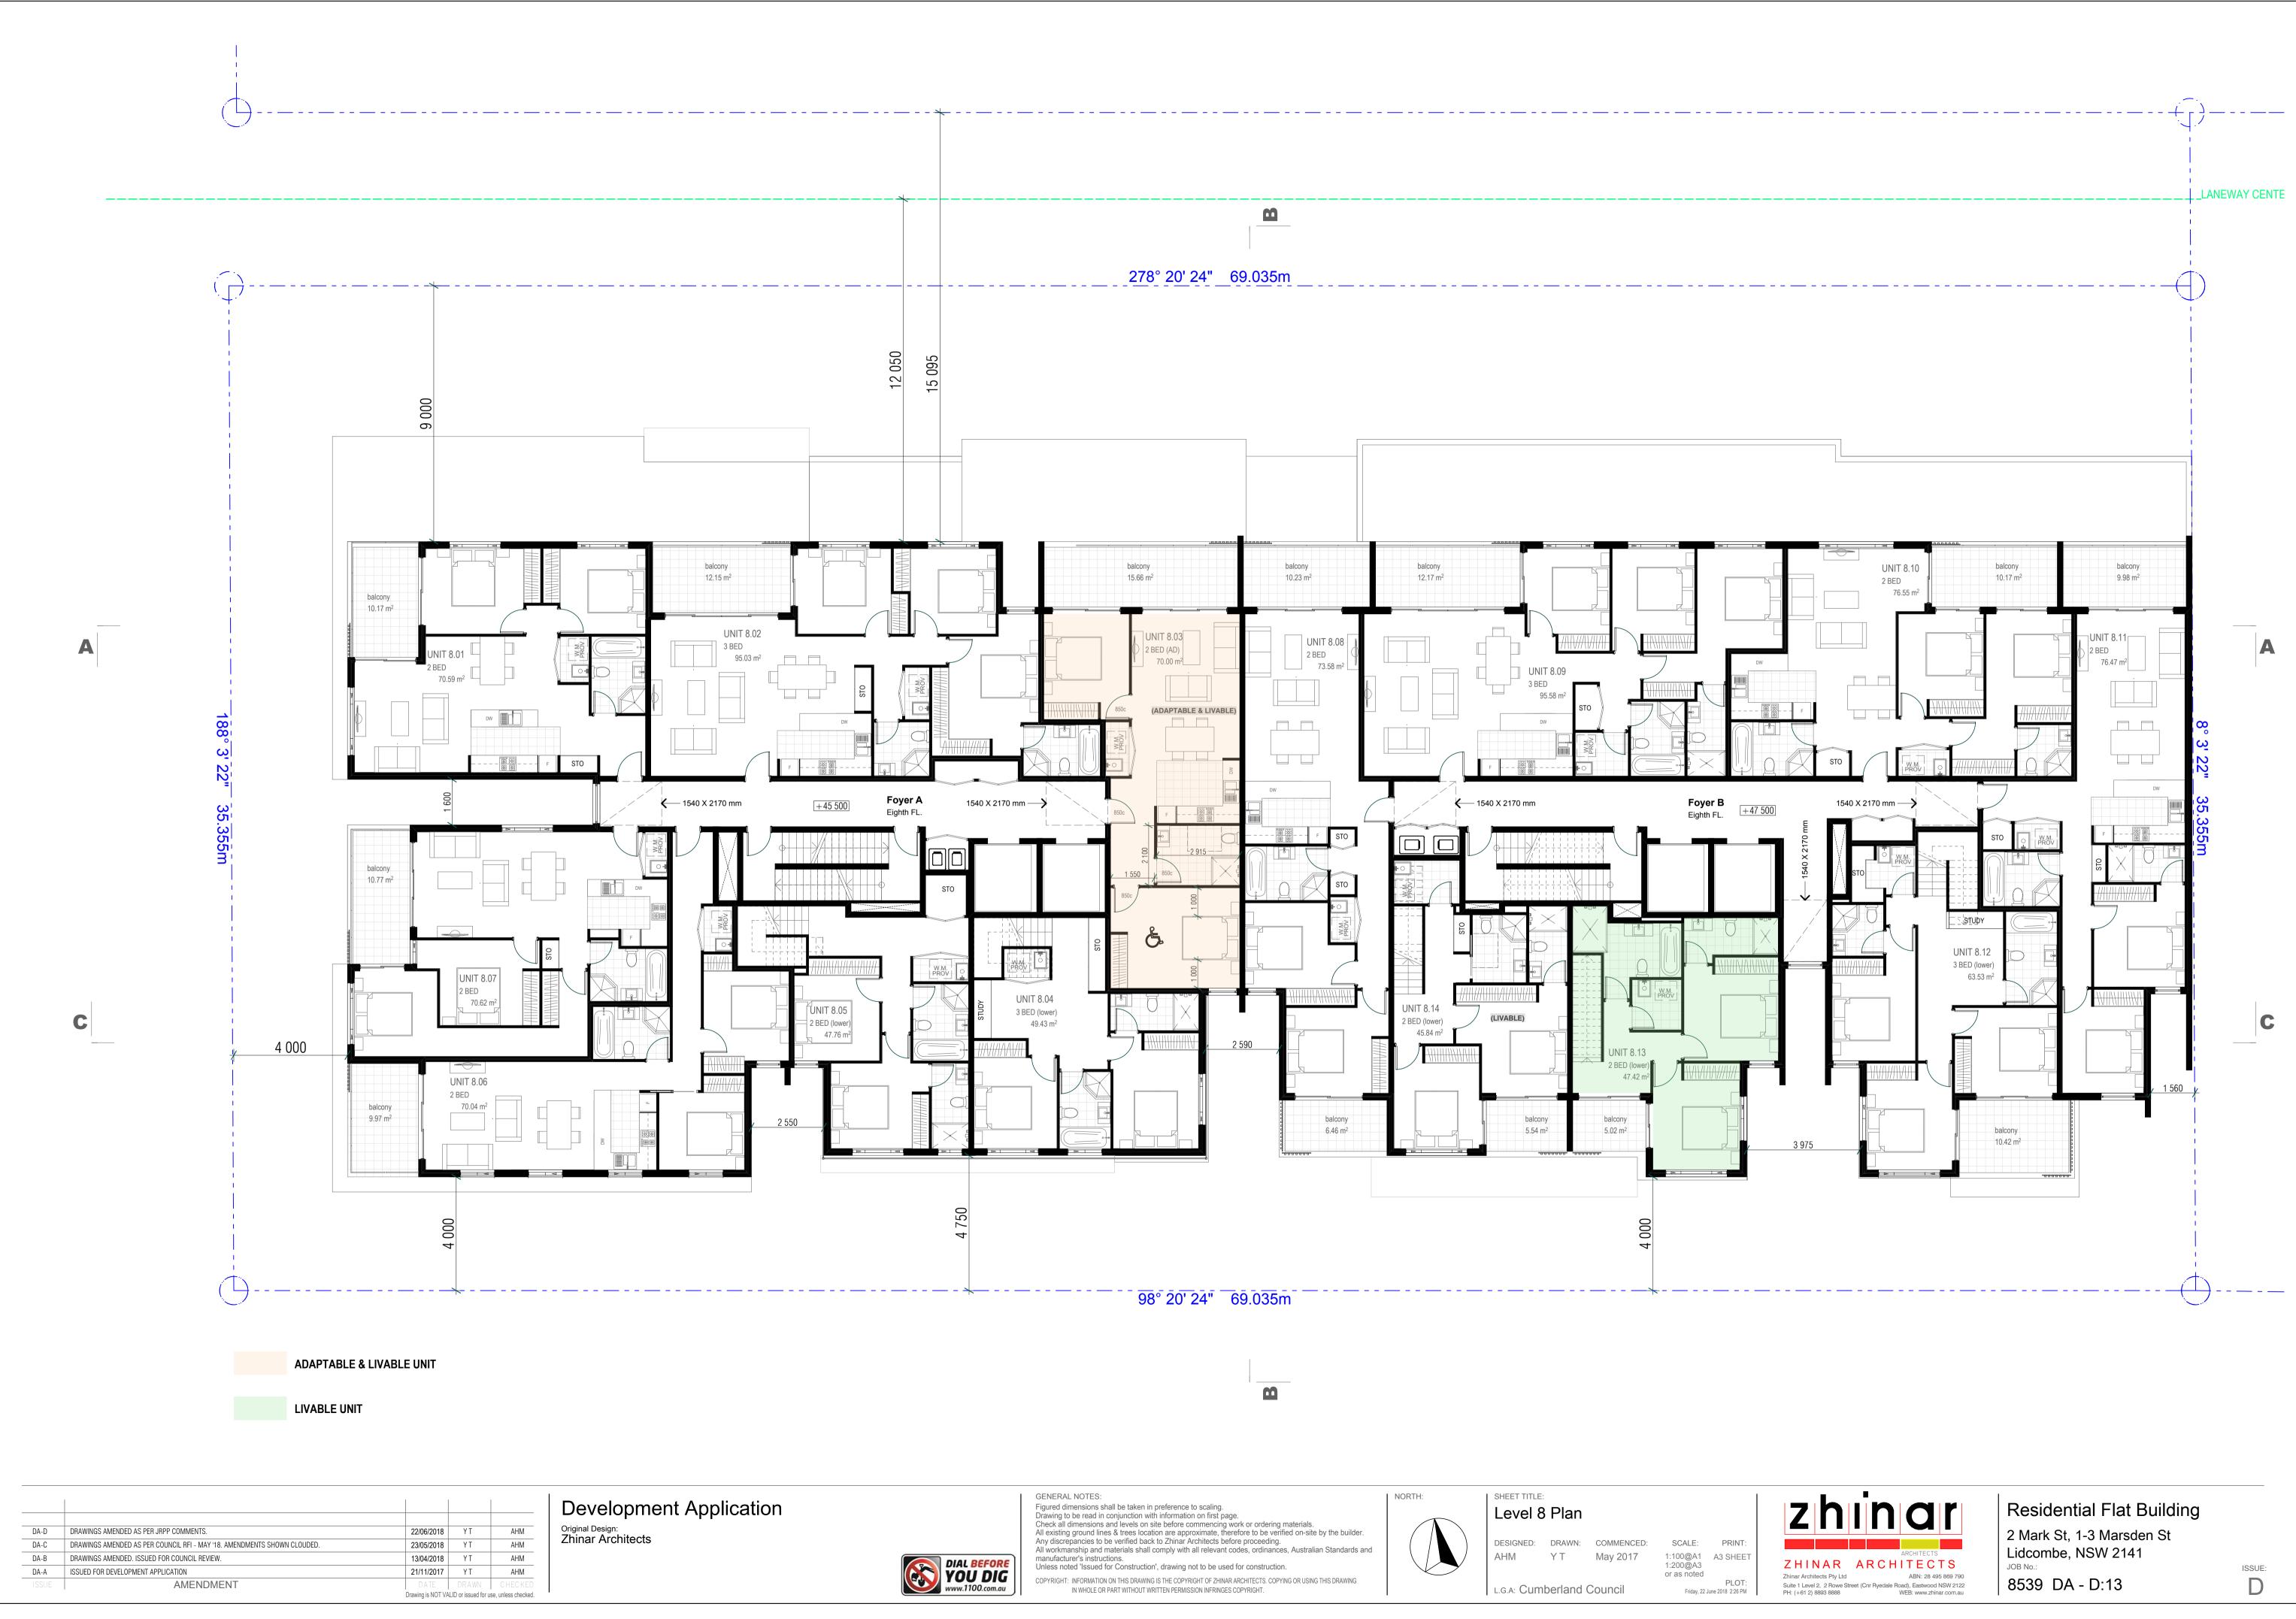

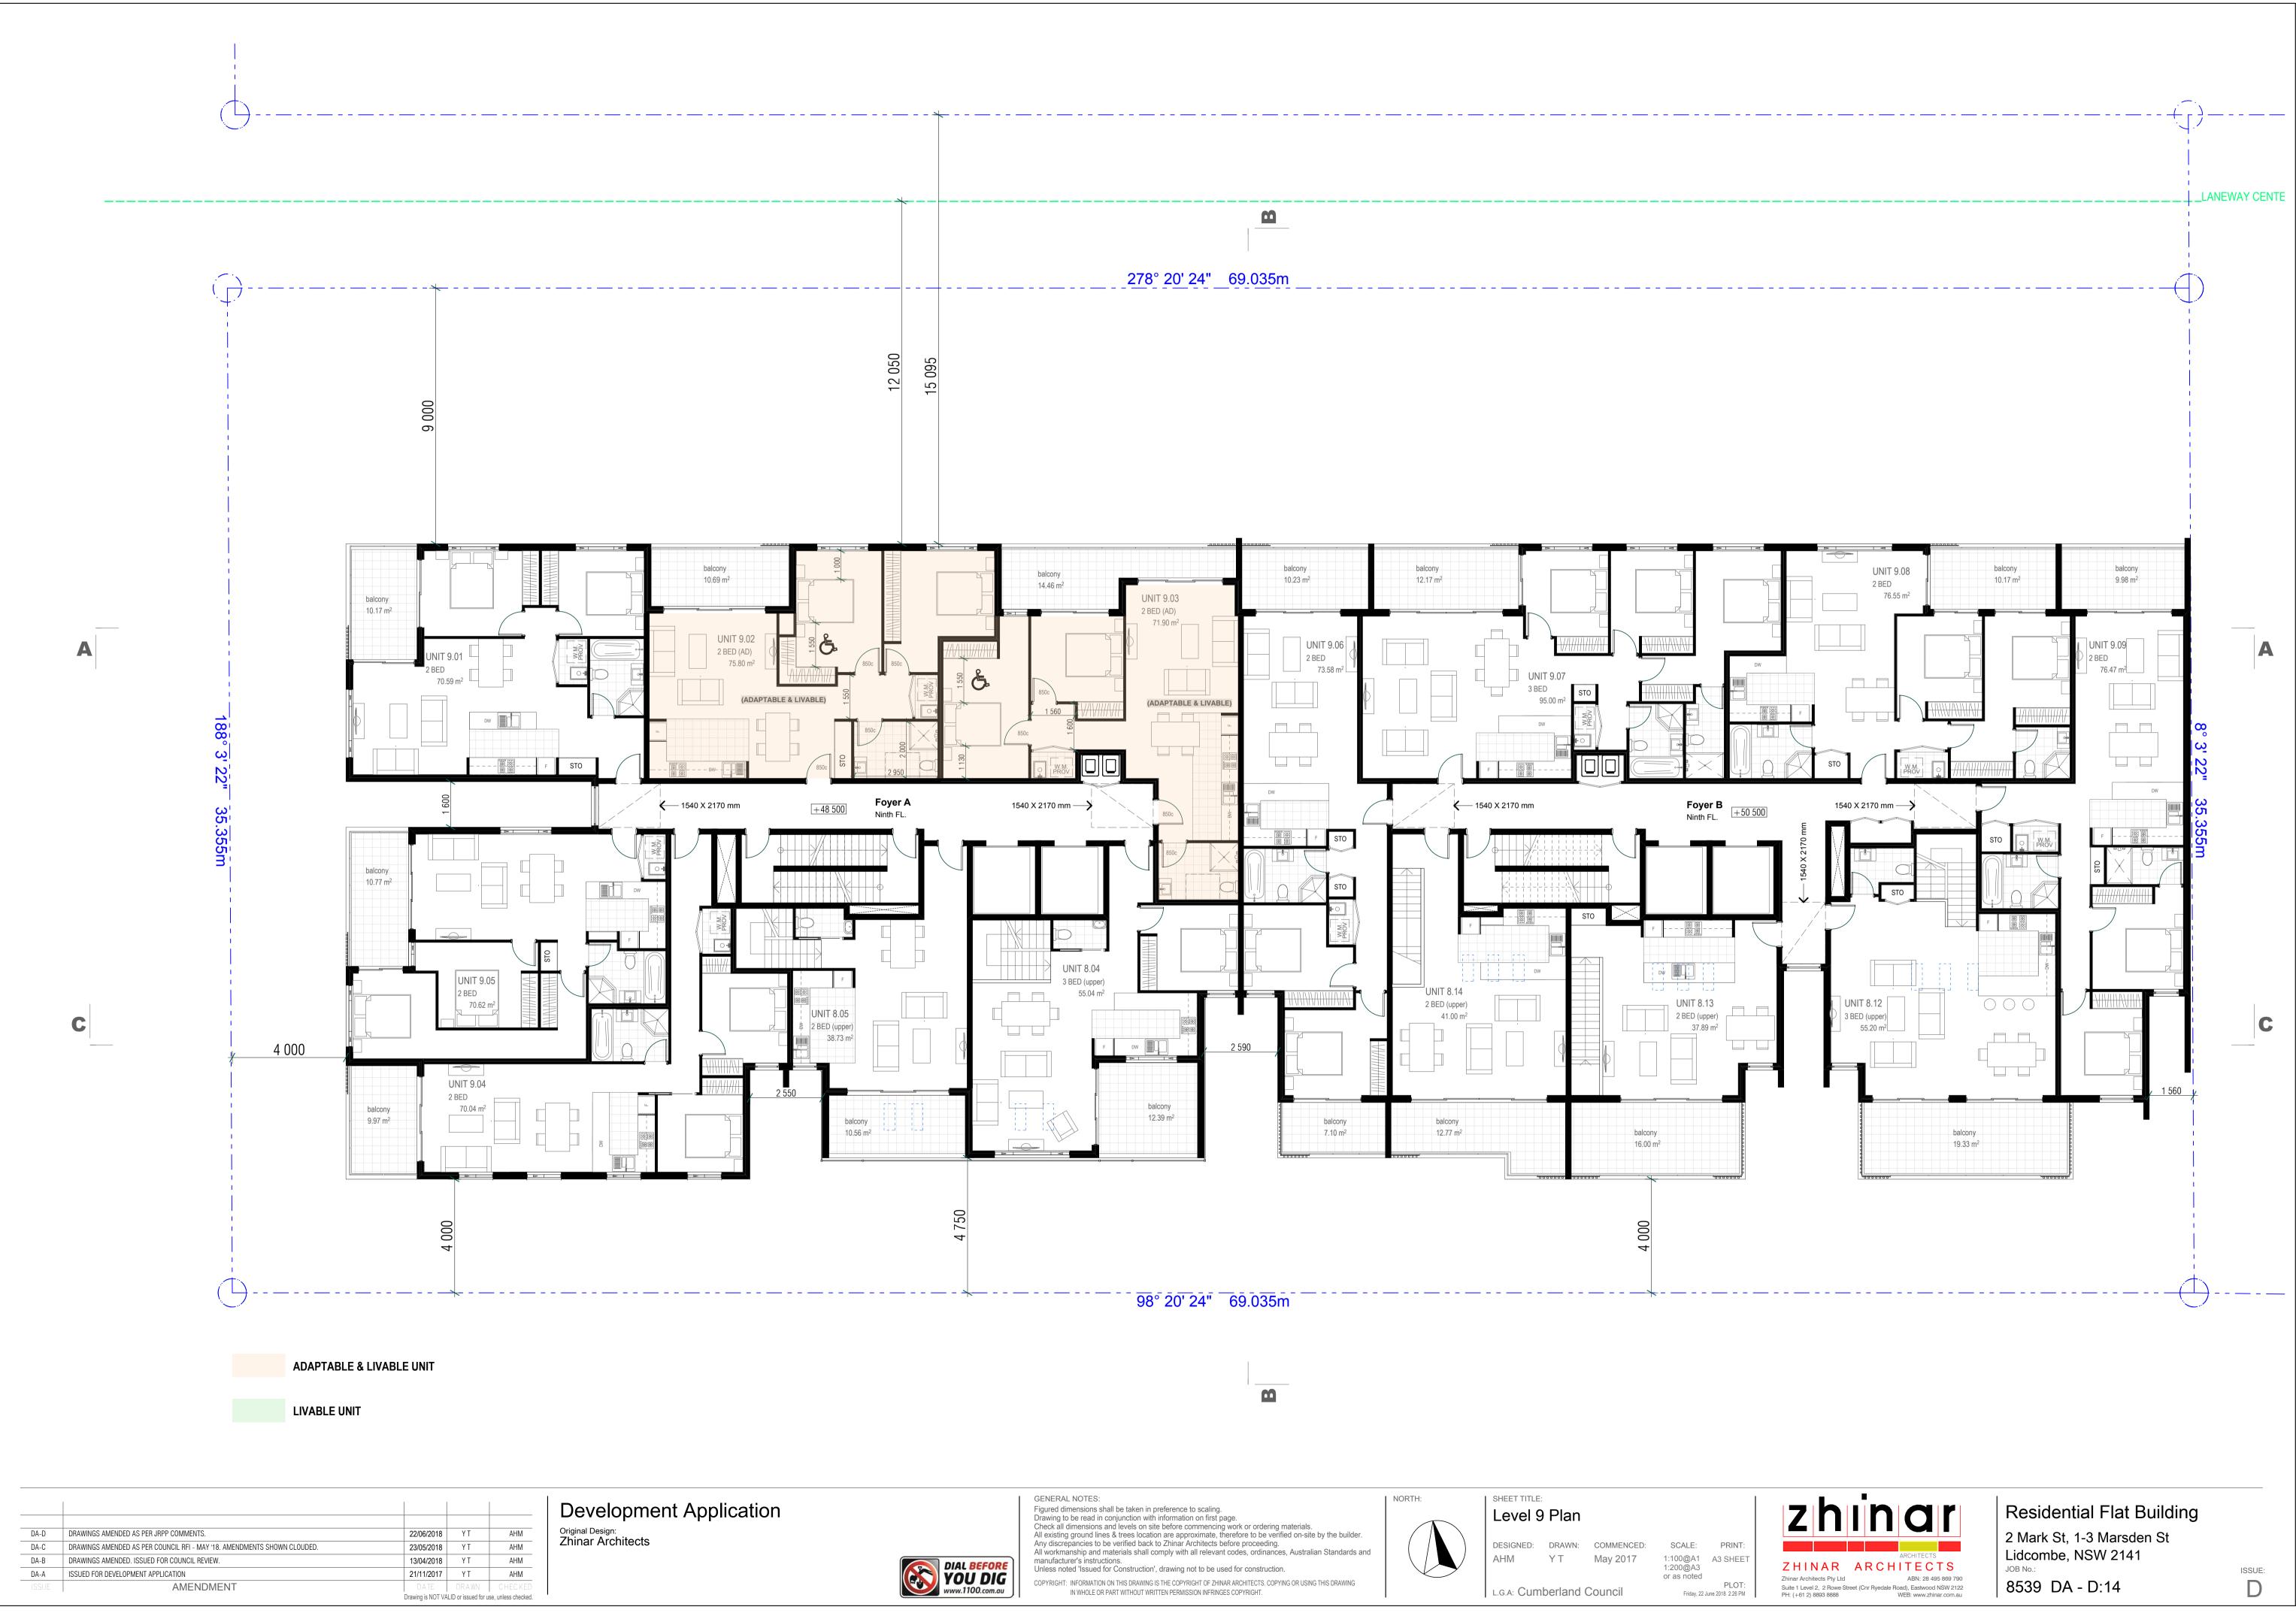

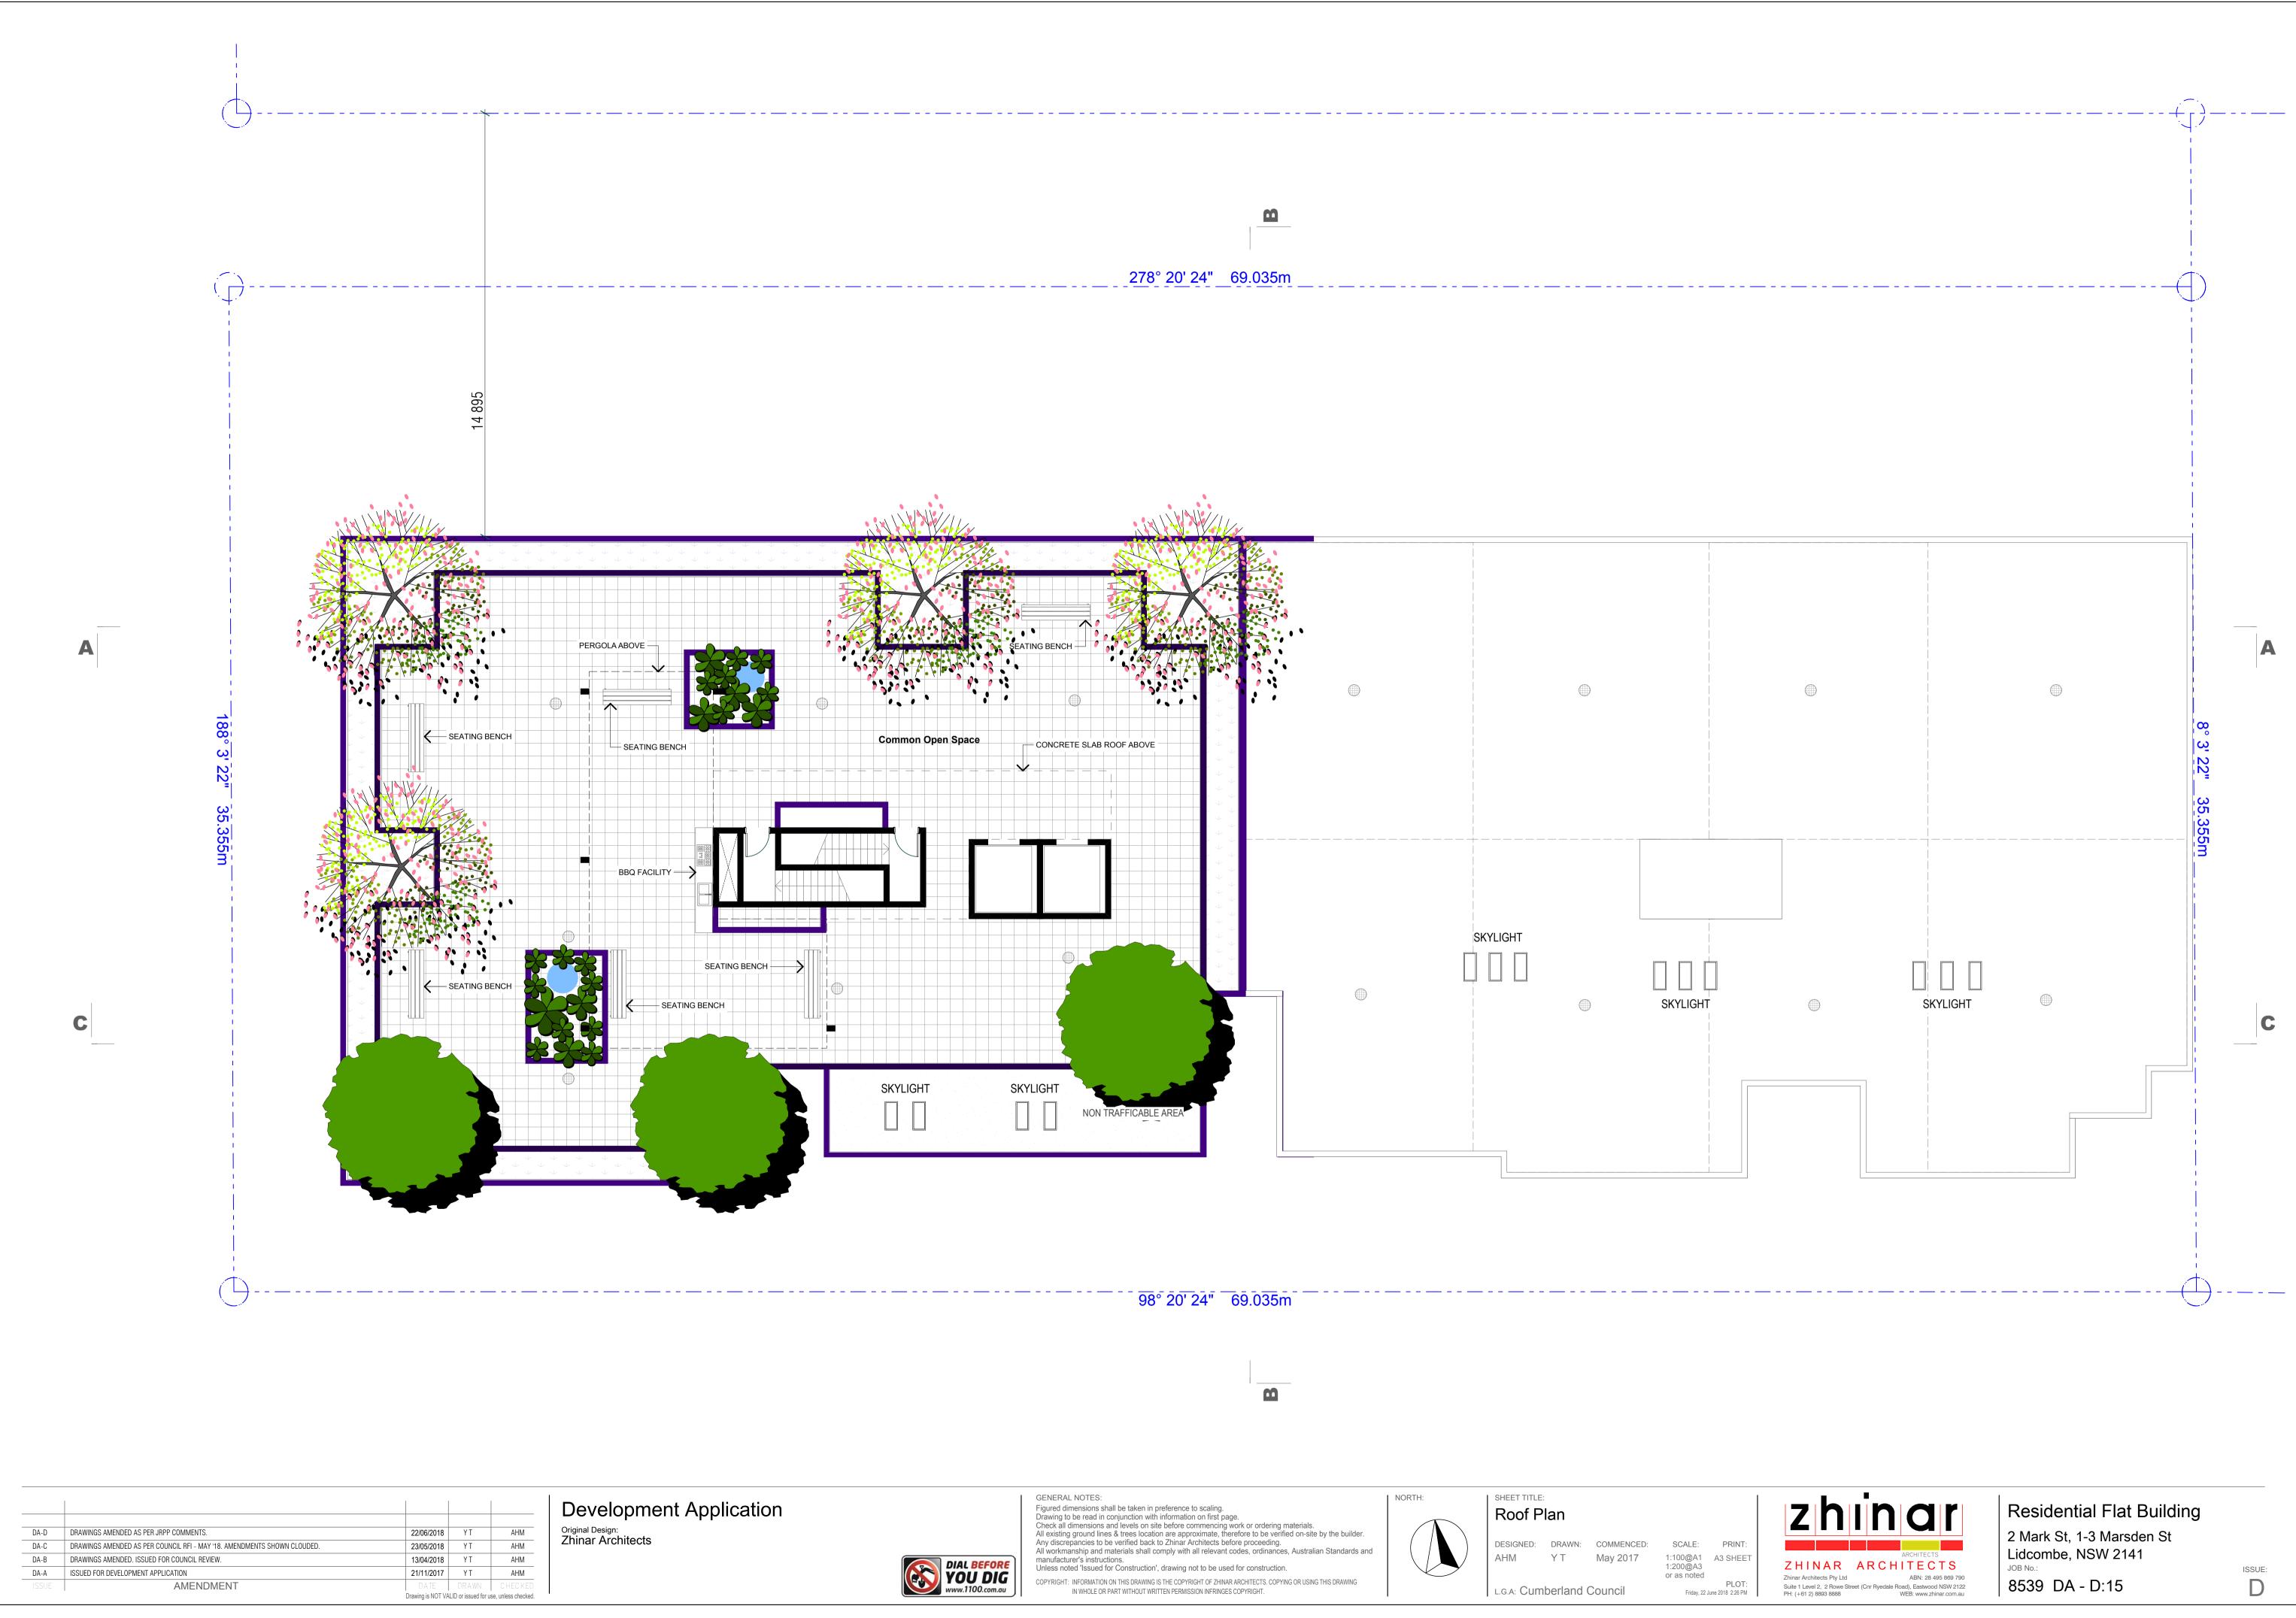

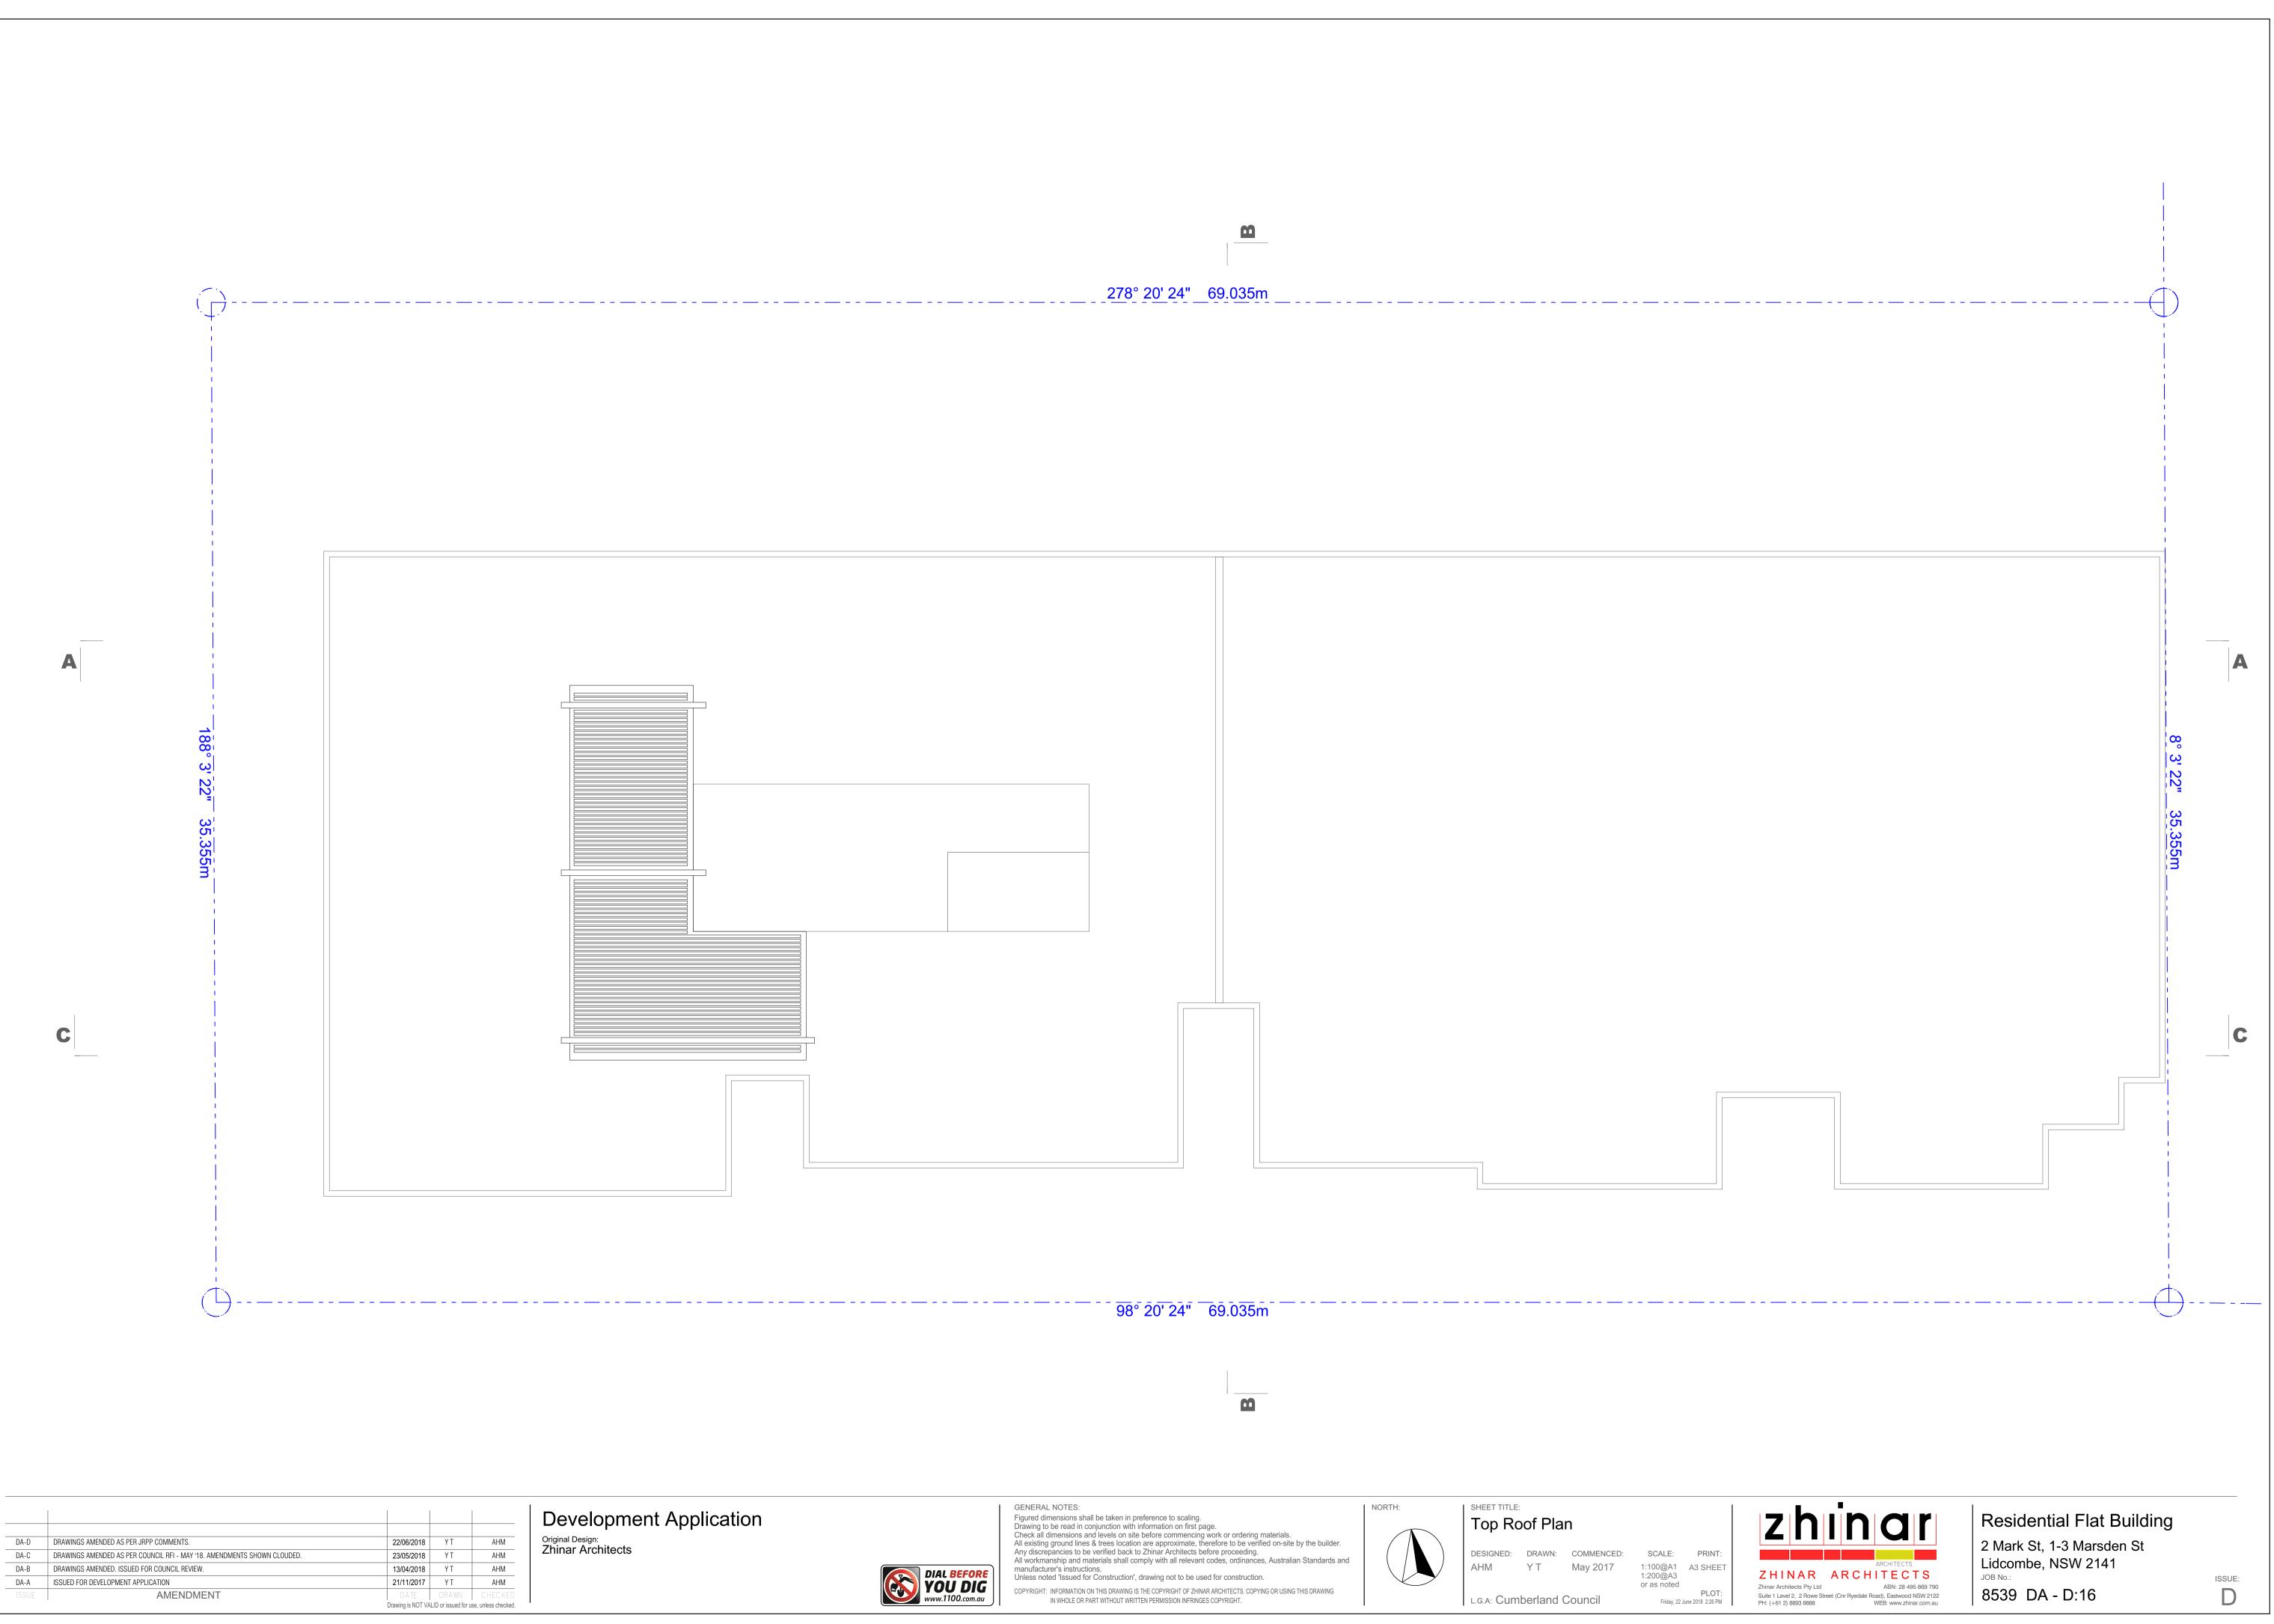






L.G.A: Cumberland Council Friday, 22 June 2018 2:26 PM



## MATERIAL SCHEDULE

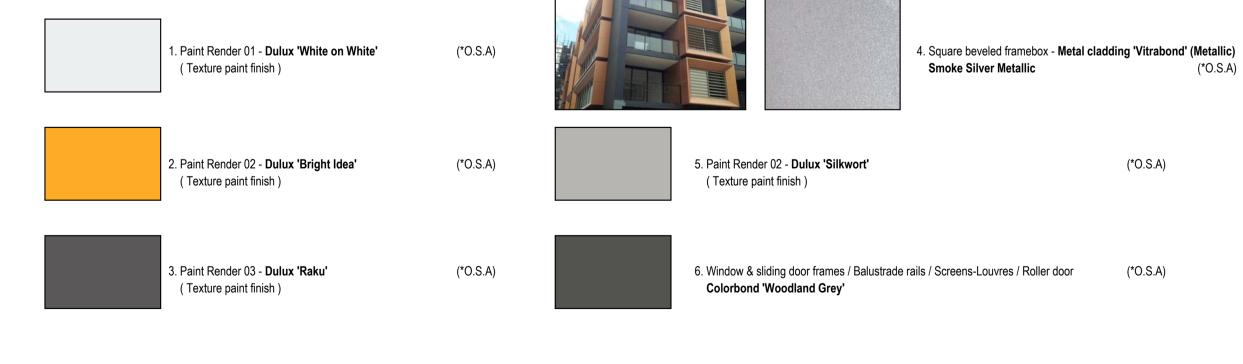

DA-D	DRAWINGS AMENDED AS PER JRPP COMMENTS.	22/06/2018	ΥT	AHM
DA-C	DRAWINGS AMENDED AS PER COUNCIL RFI - MAY '18. AMENDMENTS SHOWN CLOUDED.	23/05/2018	ΥT	AHM
DA-B	DRAWINGS AMENDED. ISSUED FOR COUNCIL REVIEW.	13/04/2018	ΥT	AHM
DA-A	ISSUED FOR DEVELOPMENT APPLICATION	21/11/2017	ΥT	AHM
ISSUE	AMENDMENT	DATE	DRAWN	C HEC KED
		Drawing is NOT VA	LID or issued for u	se, unless checked.

## **Development Application** Original Design: Zhinar Architects

(\*O.S.A)



7. Translucent / frosted glass balustrade (Level 2-4)

(\*O.S.A)

(\*O.S.A)

(\*O.S.A)



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NORTH:

SHEET TITLE: North Elevation - Marsden St

NOTUT				
DESIGNED:	DRAWN:	COMMENCED:	SCALE:	PRINT:
AHM	ΥT	May 2017	1:100@A1 1:200@A3 or as noted	A3 SHEET
l.g.a: Cun	nberland	Council	Friday, 22 J	PLOT: lune 2018 2:26 PM




**Residential Flat Building** 2 Mark St, 1-3 Marsden St Lidcombe, NSW 2141 JOB No.: 8539 DA - D:18




D	DRAWINGS AMENDED AS PER JRPP COMMENTS.	22/06/2018	ΥT	AHM
С	DRAWINGS AMENDED AS PER COUNCIL RFI - MAY '18. AMENDMENTS SHOWN CLOUDED.	23/05/2018	ΥT	AHM
В	DRAWINGS AMENDED. ISSUED FOR COUNCIL REVIEW.	13/04/2018	ΥT	AHM
A	ISSUED FOR DEVELOPMENT APPLICATION	21/11/2017	ΥT	AHM
UE	AMENDMENT	DATE	DRAWN	CHECKED
		Drawing is NOT V/	I ID or issued for u	so unloss chockod



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L.G.A: Cun	nberland	Council	Friday, 22 J	PLOT June 2018 2:27 PI

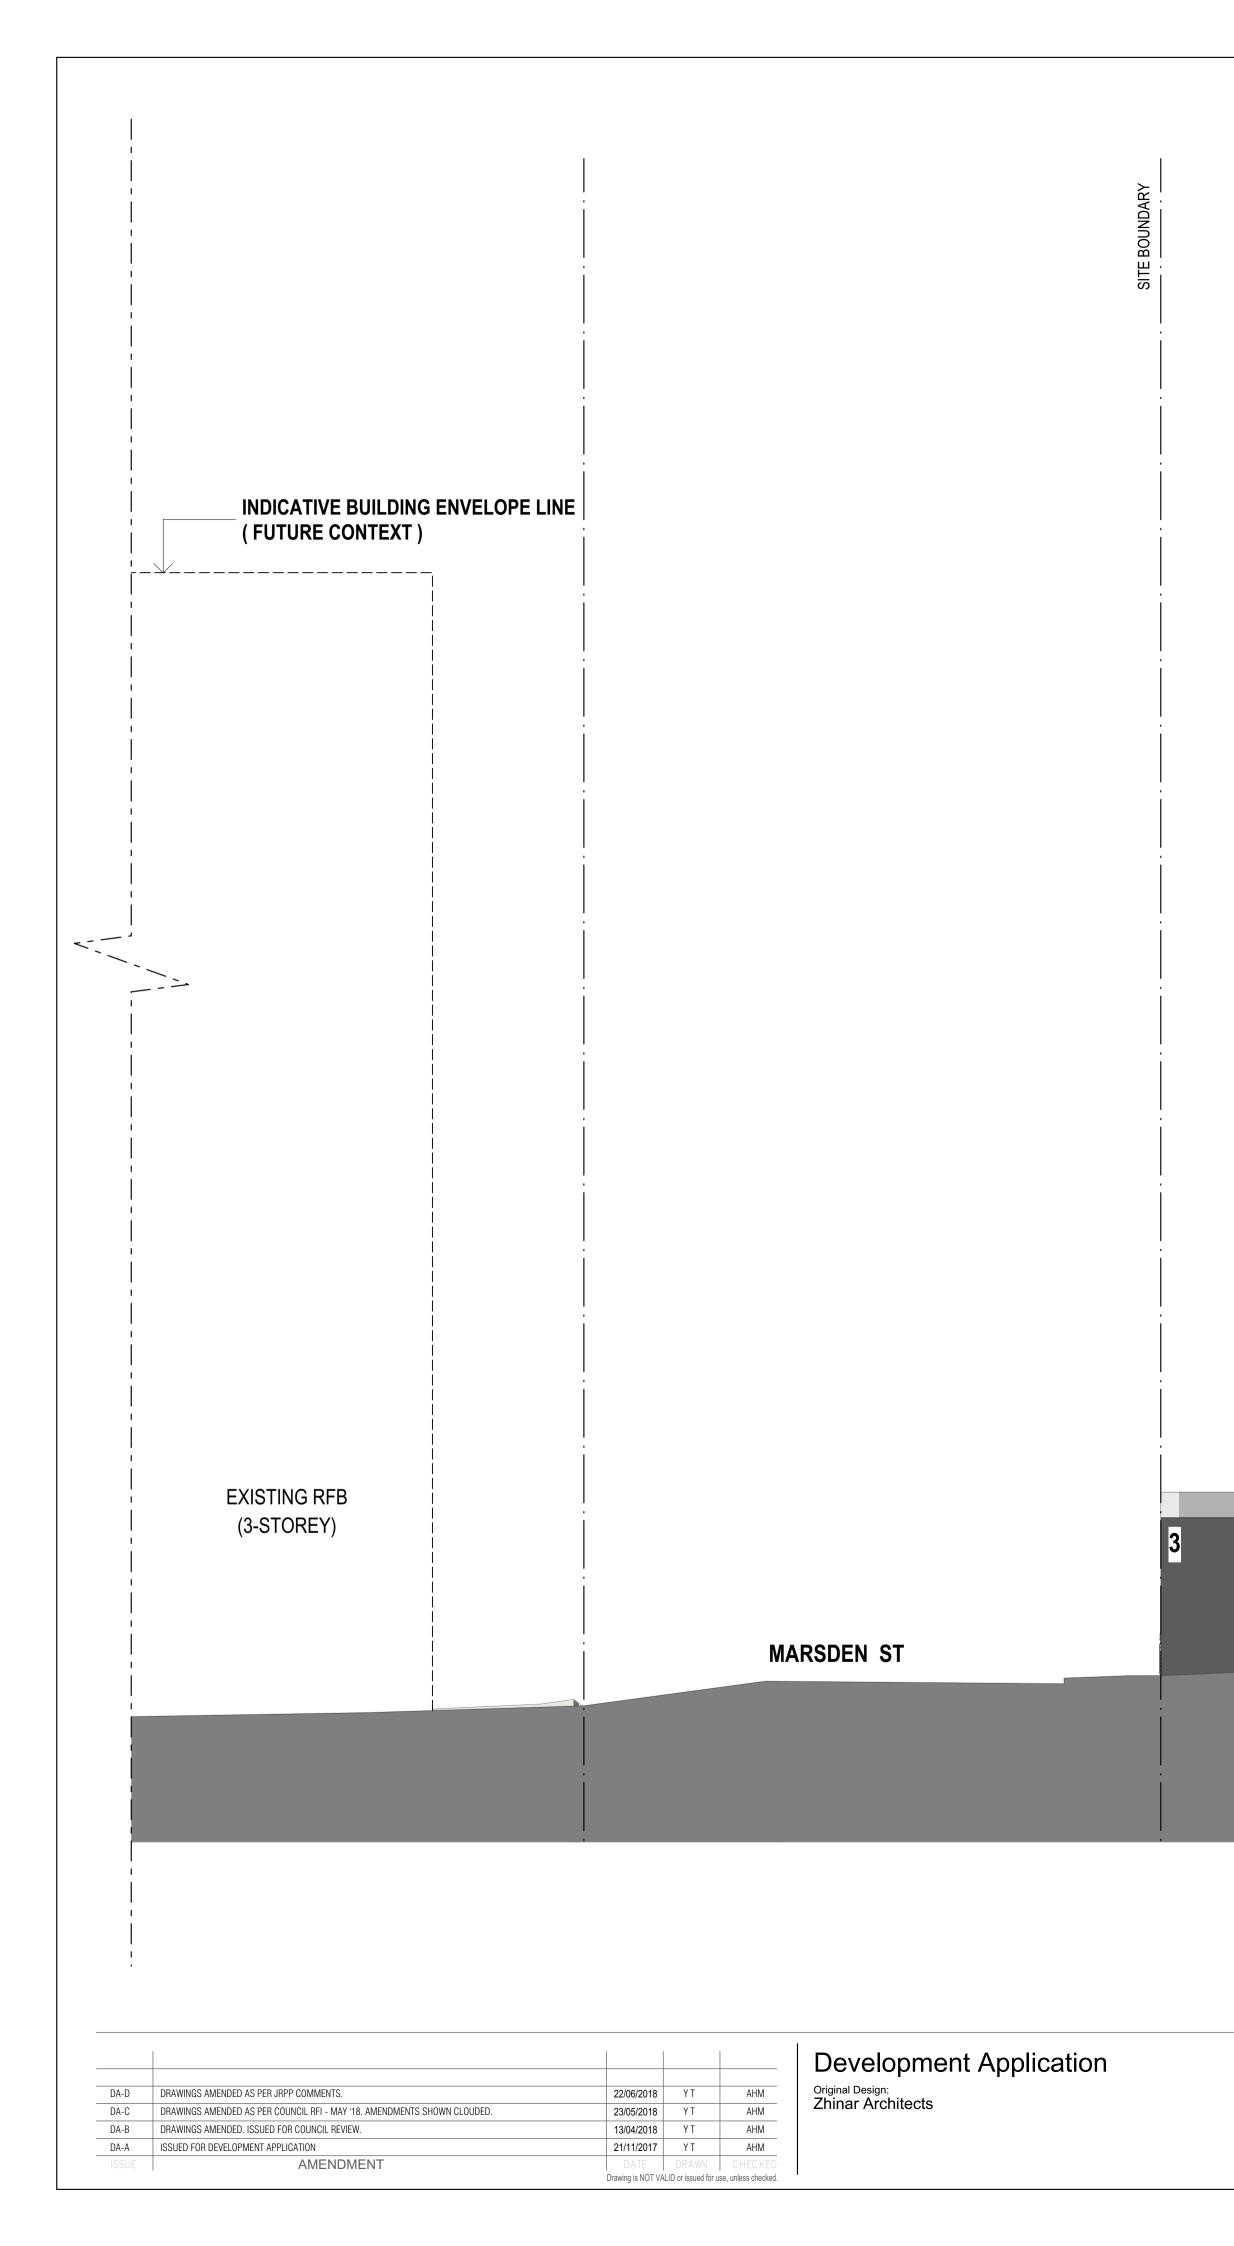

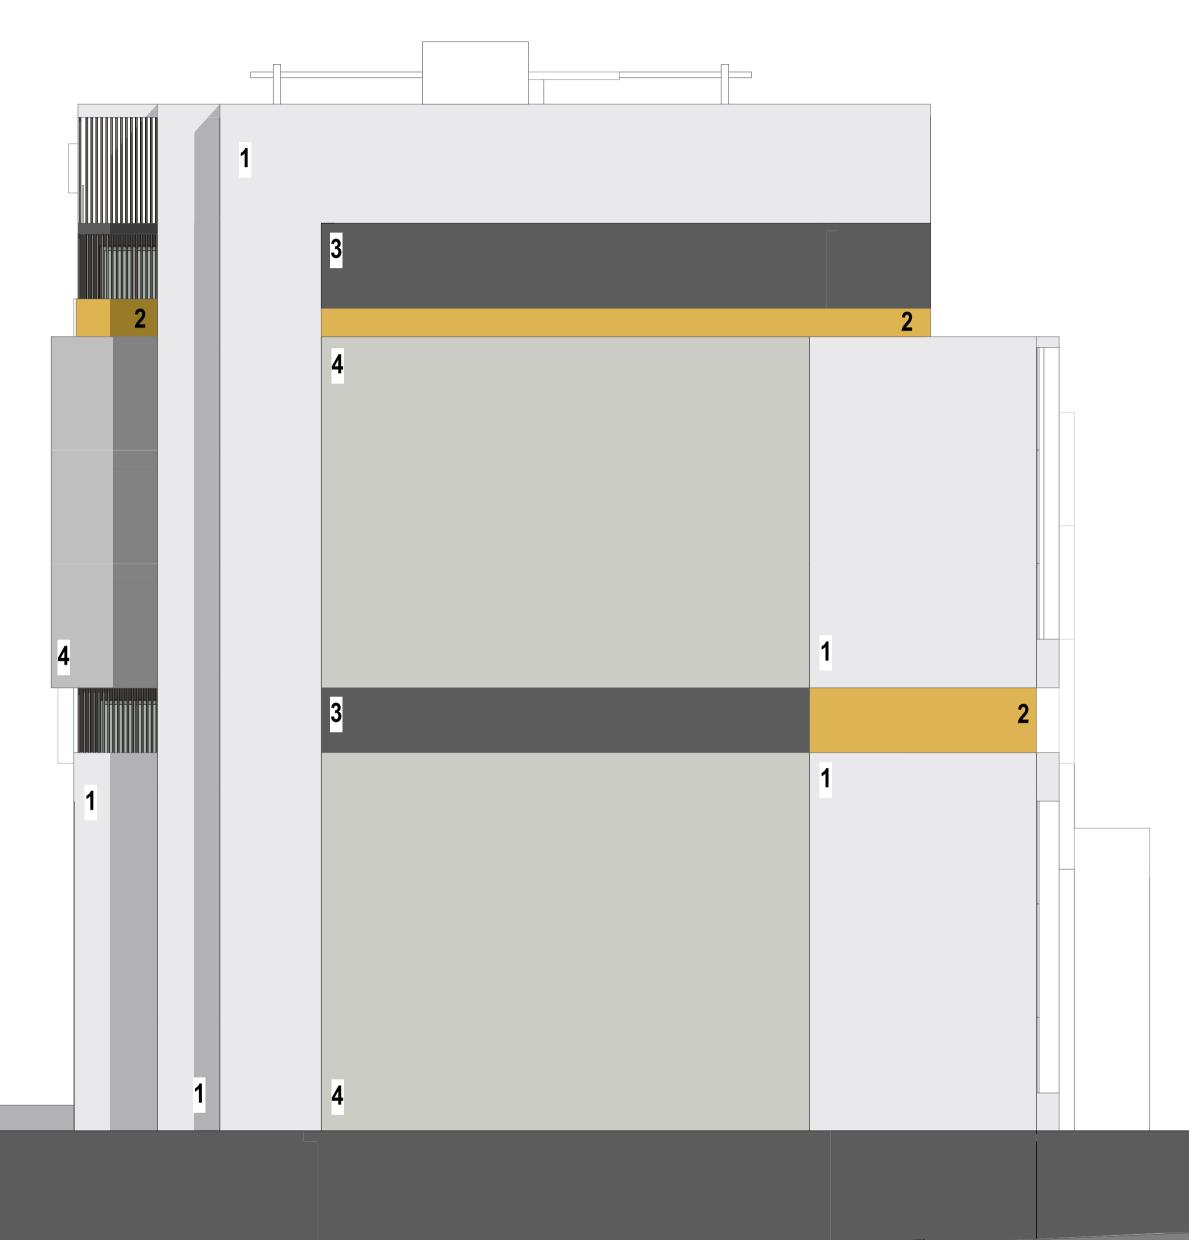





GENERAL NOTES:
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NORTH:

East Elevation

DESIGNED: DRAWN: COMMENCED: SCALE: PRINT: AHM YT May 2017 1:100@A1 A3 SHEET 1:200@A3 or as noted L.G.A: Cumberland Council Friday, 22 June 2018 2:27 PM



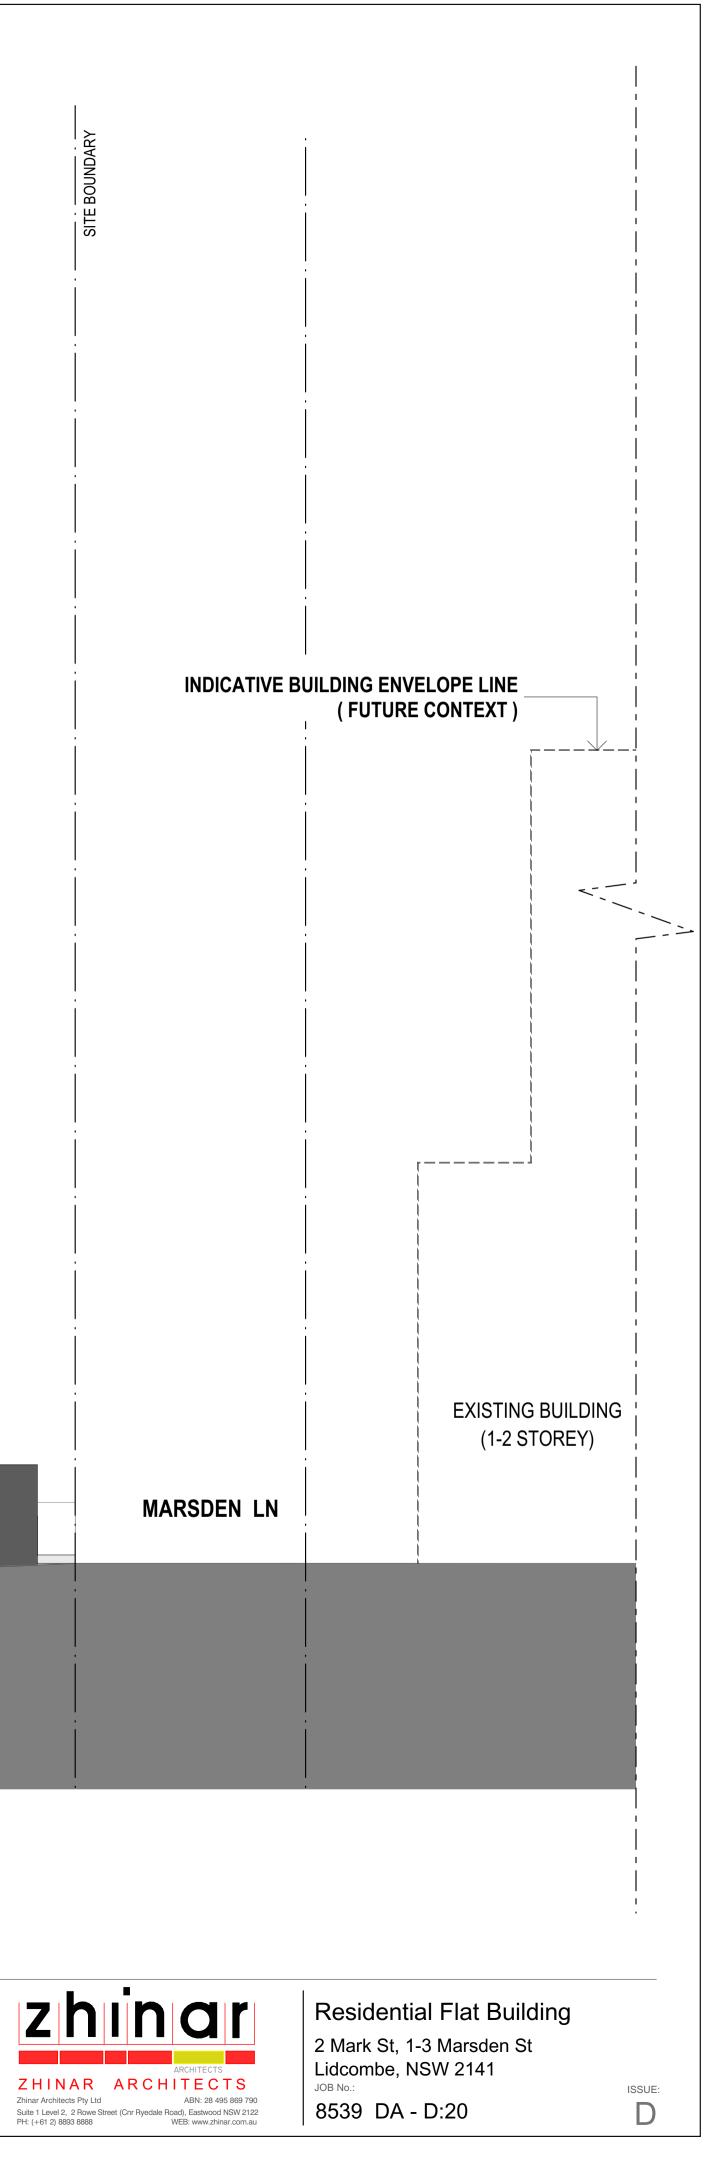
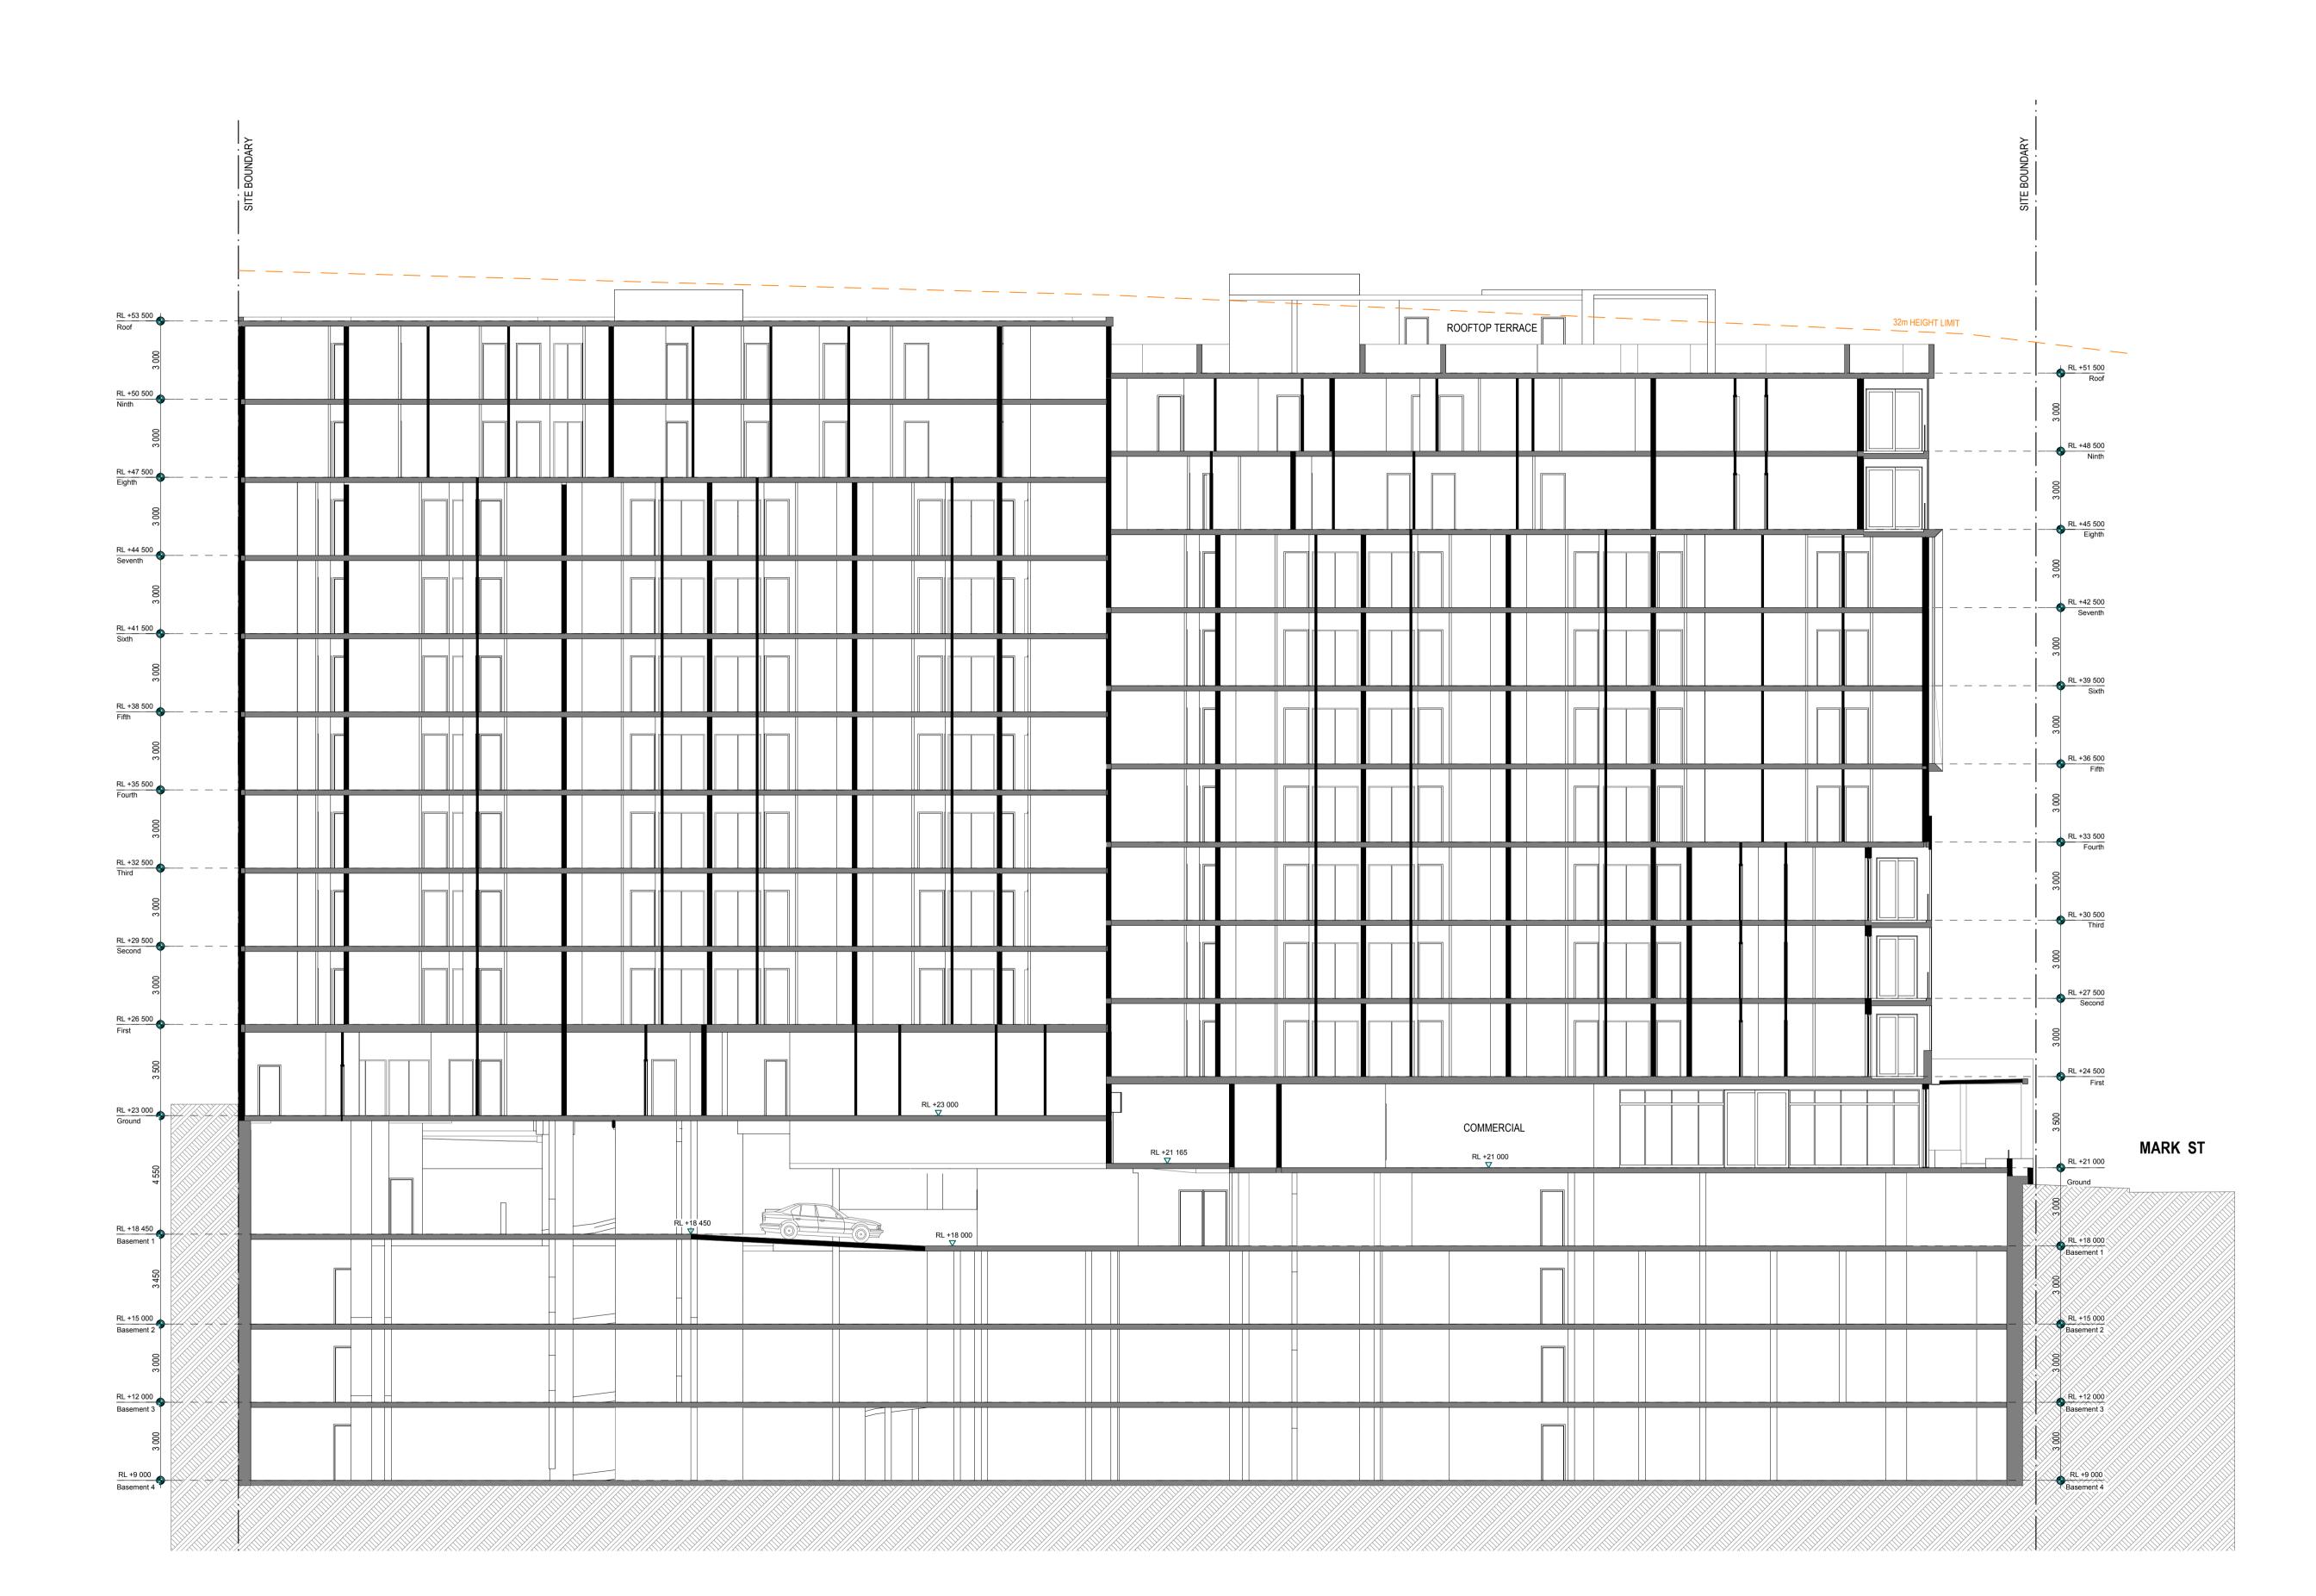
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DA-D	DRAWINGS AMENDED AS PER JRPP COMMENTS.	22/06/2018	ΥT	AHM
DA-C	DRAWINGS AMENDED AS PER COUNCIL RFI - MAY '18. AMENDMENTS SHOWN CLOUDED.	23/05/2018	ΥT	AHM
DA-B	DRAWINGS AMENDED. ISSUED FOR COUNCIL REVIEW.	13/04/2018	ΥT	AHM
DA-A	ISSUED FOR DEVELOPMENT APPLICATION	21/11/2017	ΥT	AHM
ISSUE	AMENDMENT	DATE	DRAWN	CHECKED
		Drawing is NOT VA	ALID or issued for u	se, unless checked.



GENERAL NOTES:

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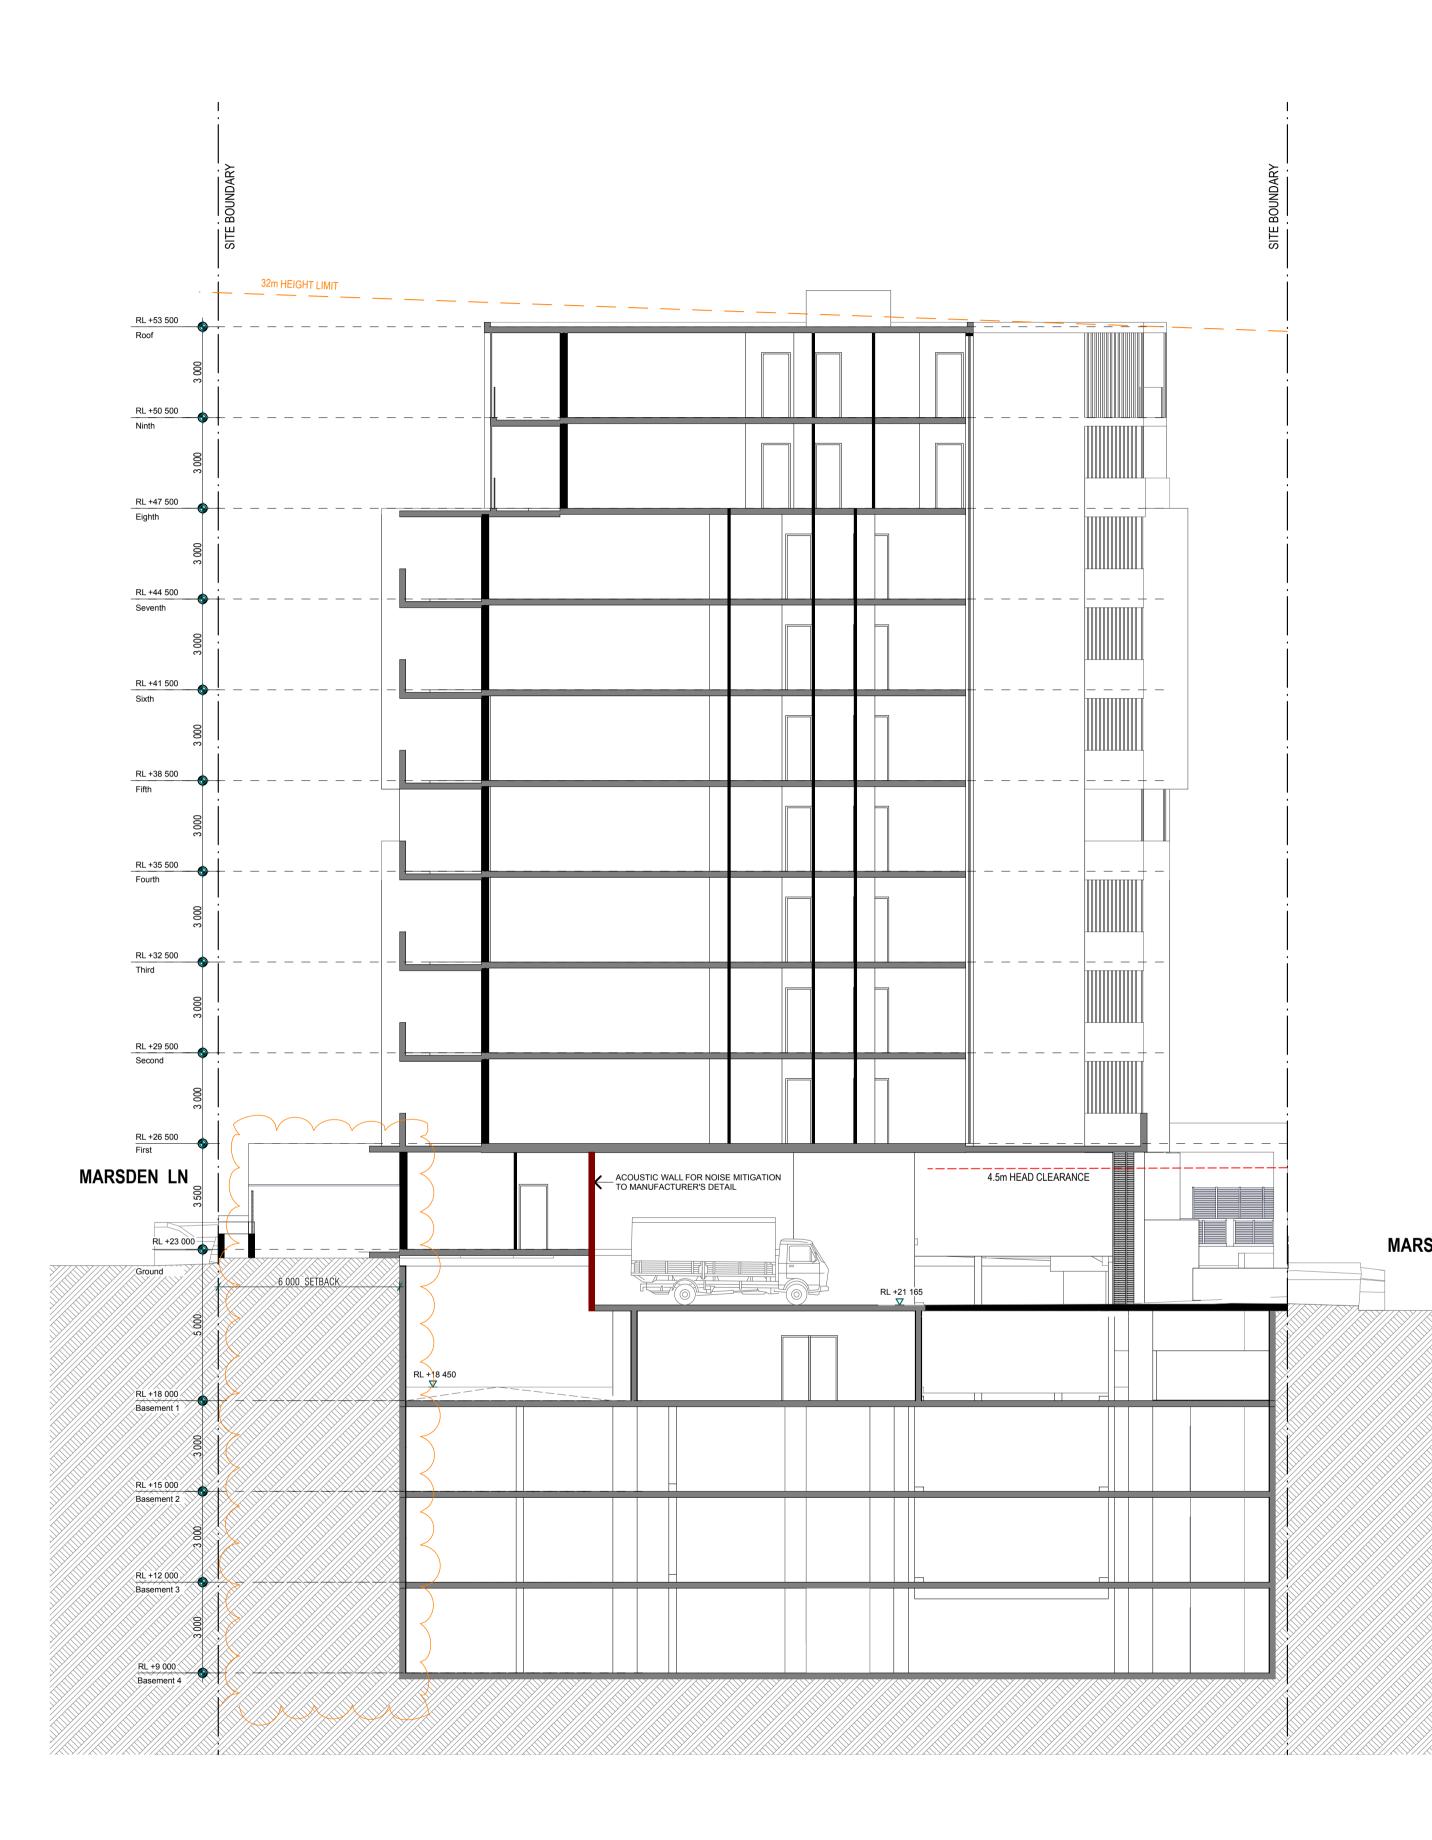
NORTH:

SHEET TITLE:

Section A DESIGNED: DRAWN: COMMENCED: SCALE: PRINT: 1:100@A1 A3 SHEET 1:200@A3 or as noted AHM YT May 2017 PLOT: L.G.A: Cumberland Council Friday, 22 June 2018 2:27 PM



Residential Flat Building 2 Mark St, 1-3 Marsden St Lidcombe, NSW 2141 JOB No.: 8539 DA - D:21



		1	I	
DA-D	DRAWINGS AMENDED AS PER JRPP COMMENTS.	22/06/2018	ΥT	AHM
DA-C	DRAWINGS AMENDED AS PER COUNCIL RFI - MAY '18. AMENDMENTS SHOWN CLOUDED.	23/05/2018	ΥT	AHM
DA-B	DRAWINGS AMENDED. ISSUED FOR COUNCIL REVIEW.	13/04/2018	ΥT	AHM
DA-A	ISSUED FOR DEVELOPMENT APPLICATION	21/11/2017	ΥT	AHM
ISSUE	AMENDMENT	DATE	DRAWN	CHECKED
		Drawing is NOT VA	ALID or issued for u	se, unless checked.

## MARSDEN ST

REVISION - D :

- PROVIDE 6m SETBACK AT REAR (NORTH EASTERN) FOR DEEP SOIL. CAR PARKING LAYOUT & NUMBER UPDATED. - EXISTING NEIGBORING TREE AT MARSDEN LANE CUL-DE-SAC CONFIRMED CAN BE RETAINED.



GENERAL NOTES:

GENERAL NOTES: Figured dimensions shall be taken in preference to scaling. Drawing to be read in conjunction with information on first page. Check all dimensions and levels on site before commencing work or ordering materials. All existing ground lines & trees location are approximate, therefore to be verified on-site by the builder. Any discrepancies to be verified back to Zhinar Architects before proceeding. All workmanship and materials shall comply with all relevant codes, ordinances, Australian Standards and manufacturer's instructions. Unloce pated for Construction! drawing pet to be used for construction. Unless noted 'Issued for Construction', drawing not to be used for construction. COPYRIGHT: INFORMATION ON THIS DRAWING IS THE COPYRIGHT OF ZHINAR ARCHITECTS. COPYING OR USING THIS DRAWING IN WHOLE OR PART WITHOUT WRITTEN PERMISSION INFRINGES COPYRIGHT.

NORTH:

SHEET TITLE:

Section B DESIGNED: DRAWN: COMMENCED: SCALE: PRINT: 1:100@A1 A3 SHEET 1:200@A3 or as noted AHM YT May 2017 PLOT: L.G.A: Cumberland Council Friday, 22 June 2018 2:27 PM



Residential Flat Building 2 Mark St, 1-3 Marsden St Lidcombe, NSW 2141 JOB No.: 8539 DA - D:22

ISSUE:

D



		1		
DA-D	DRAWINGS AMENDED AS PER JRPP COMMENTS.	22/06/2018	ΥT	AHM
DA-C	DRAWINGS AMENDED AS PER COUNCIL RFI - MAY '18. AMENDMENTS SHOWN CLOUDED.	23/05/2018	ΥT	AHM
DA-B	DRAWINGS AMENDED. ISSUED FOR COUNCIL REVIEW.	13/04/2018	ΥT	AHM
DA-A	ISSUED FOR DEVELOPMENT APPLICATION	21/11/2017	ΥT	AHM
ISSUE	AMENDMENT	DATE	DRAWN	CHECKED
	Drawing is NOT VALID or issued for use, unless checked.			



GENERAL NOTES:

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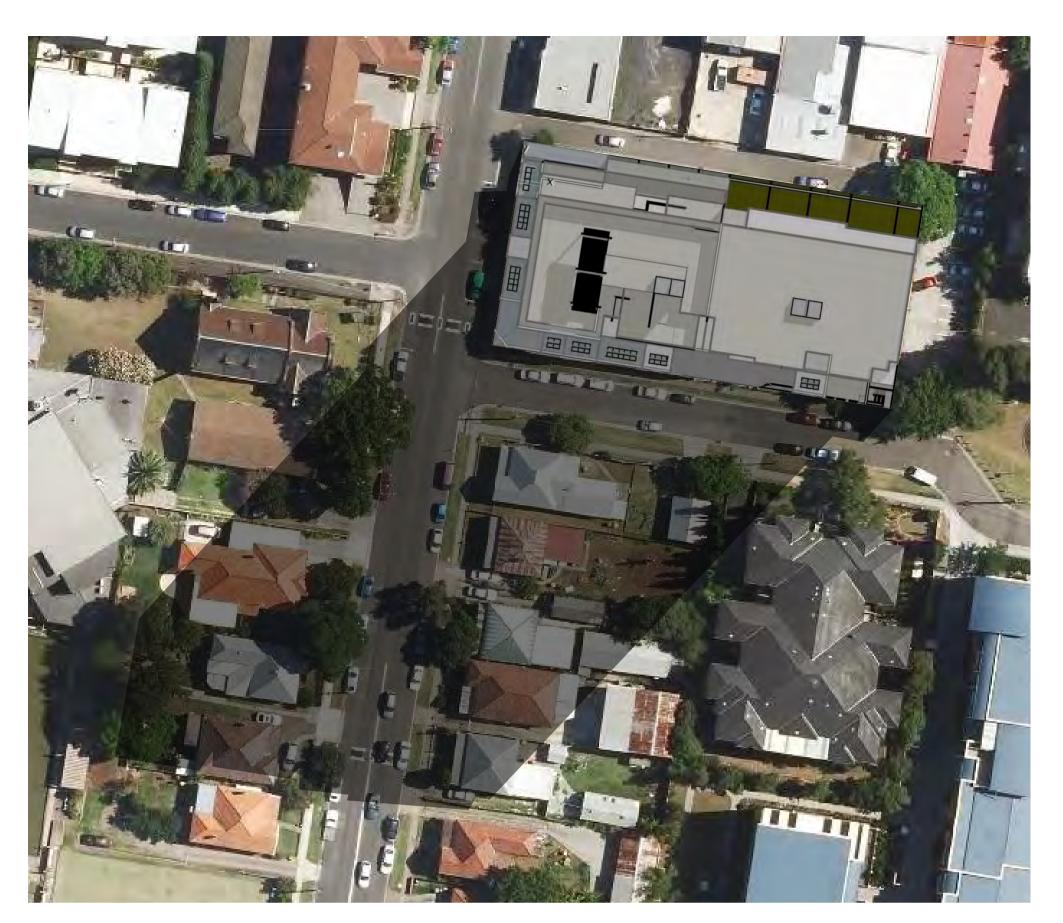
NORTH:

SHEET TITLE: Section C

DESIGNED: DRAWN: COMMENCED: SCALE: PRINT: 1:100@A1 A3 SHEET 1:200@A3 or as noted AHM YT May 2017 PLOT: L.G.A: Cumberland Council Friday, 22 June 2018 2:27 PM



Residential Flat Building 2 Mark St, 1-3 Marsden St Lidcombe, NSW 2141 JOB No.: 8539 DA - D:23




SHADOW - 9AM (21st JUNE)




## Mark Street Elevation

DA-D	DRAWINGS AMENDED AS PER JRPP COMMENTS.	22/06/2018	ΥT	AHM
DA-C	DRAWINGS AMENDED AS PER COUNCIL RFI - MAY '18. AMENDMENTS SHOWN CLOUDED.	23/05/2018	ΥT	AHM
DA-B	DRAWINGS AMENDED. ISSUED FOR COUNCIL REVIEW.	13/04/2018	ΥT	AHM
DA-A	ISSUED FOR DEVELOPMENT APPLICATION	21/11/2017	ΥT	AHM
ISSUE	AMENDMENT	DATE	DRAWN	CHECKED
		Drawing is NOT VA	LID or issued for u	se. unless checked.

**Development Application** Original Design: Zhinar Architects

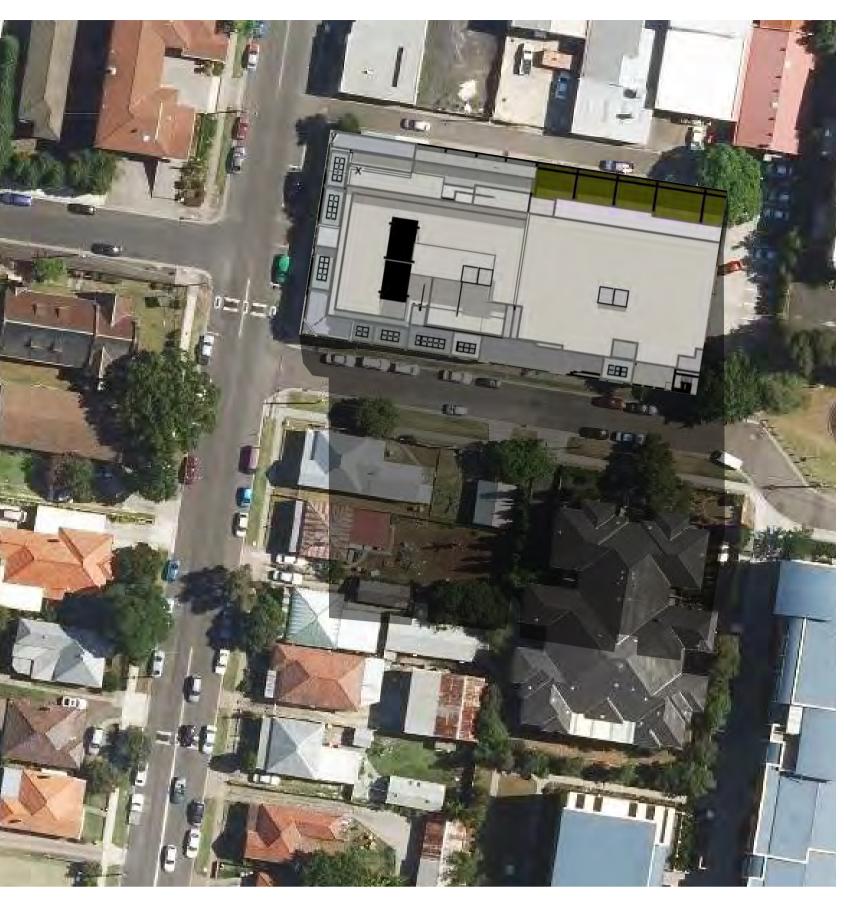


SHADOW - 12PM (21st JUNE)

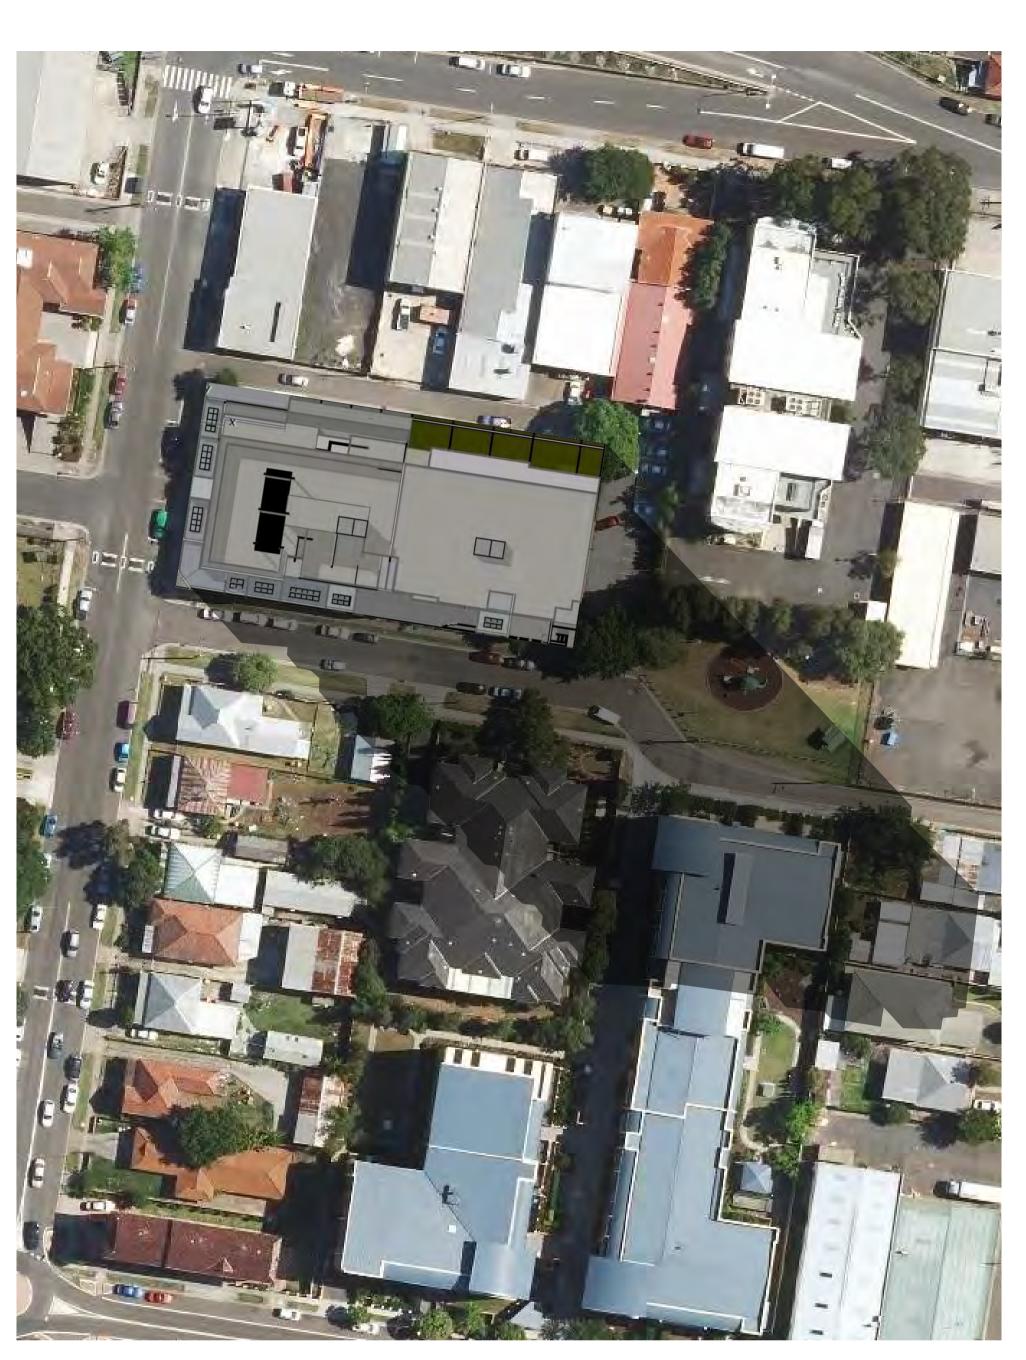

DIAL BEFORE YOU DIG www.1100.com.au

GENERAL NOTES: GENERAL NOTES: Figured dimensions shall be taken in preference to scaling. Drawing to be read in conjunction with information on first page. Check all dimensions and levels on site before commencing work or ordering materials. All existing ground lines & trees location are approximate, therefore to be verified on-site by the builder. Any discrepancies to be verified back to Zhinar Architects before proceeding. All workmanship and materials shall comply with all relevant codes, ordinances, Australian Standards and manufacturer's instructions. Unless pated fiscued for Construction' drawing not to be used for construction Unless noted 'Issued for Construction', drawing not to be used for construction. COPYRIGHT: INFORMATION ON THIS DRAWING IS THE COPYRIGHT OF ZHINAR ARCHITECTS. COPYING OR USING THIS DRAWING IN WHOLE OR PART WITHOUT WRITTEN PERMISSION INFRINGES COPYRIGHT.

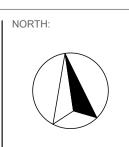

## SHEET TITLE: Shadow Diagrams (Existing Context) DESIGNED: DRAWN: COMMENCED: SCALE: PRINT: AHM YT May 2017

L.G.A: Cumberland Council

1:100@A1 A3 SHEET 1:200@A3 or as noted PLOT: Friday, 22 June 2018 2:27 PM

## SHADOW - 3PM (21st JUNE)



Residential Flat Building 2 Mark St, 1-3 Marsden St Lidcombe, NSW 2141 JOB No.: 8539 DA - D:24

# IMPACT OF PROPOSED BUILDING TO EXISTING 10-14 MARSDEN ST & RECENTLY APPROVED 4-14 MARK ST



DA-D	DRAWINGS AMENDED AS PER JRPP COMMENTS.	27/06/2018	ΥT	AHM		
DA-C	DRAWINGS AMENDED AS PER COUNCIL RFI - MAY '18. AMENDMENTS SHOWN CLOUDED.	23/05/2018	ΥT	AHM		
DA-B	DRAWINGS AMENDED. ISSUED FOR COUNCIL REVIEW.	13/04/2018	ΥT	AHM		
DA-A	ISSUED FOR DEVELOPMENT APPLICATION	21/11/2017	ΥT	AHM		
ISSUE	AMENDMENT	DATE	DRAWN	CHECKED		
	Drawing is NOT VALID or issued for use, unless checked.					

**Development Application** Original Design: Zhinar Architects



SHADOW - 9AM (21st JUNE)



SHADOW - 11AM (21st JUNE)

> GENERAL NOTES: GENERAL NOTES: Figured dimensions shall be taken in preference to scaling. Drawing to be read in conjunction with information on first page. Check all dimensions and levels on site before commencing work or ordering materials. All existing ground lines & trees location are approximate, therefore to be verified on-site by the builder. Any discrepancies to be verified back to Zhinar Architects before proceeding. All workmanship and materials shall comply with all relevant codes, ordinances, Australian Standards and manufacturer's instructions. Unless noted 'Issued for Construction', drawing not to be used for construction. COPYRIGHT: INFORMATION ON THIS DRAWING IS THE COPYRIGHT OF ZHINAR ARCHITECTS. COPYING OR USING THIS DRAWING IN WHOLE OR PART WITHOUT WRITTEN PERMISSION INFRINGES COPYRIGHT.

NORTH:



Sheet title: Shadov - 09AM	w Diag	ırams (Wiı 1	nter Sol	stice)
DESIGNED:	DRAWN:	COMMENCED:	SCALE:	PRINT:
AHM	ΥT	May 2017	1:100@A1 1:200@A3 or as noted	A3 SHEET
l.g.a: Cum	berland (	Wednesday, 27 J	PLOT: une 2018 4:18 PM	



## SHADOW - 10AM (21st JUNE)



SHADOW - 12PM (21st JUNE)

Residential Flat Building 2 Mark St, 1-3 Marsden St Lidcombe, NSW 2141 JOB No.: 8539 DA - D:25A



		1	I			
DA-D	DRAWINGS AMENDED AS PER JRPP COMMENTS.	27/06/2018	ΥT	AHM		
DA-C	DRAWINGS AMENDED AS PER COUNCIL RFI - MAY '18. AMENDMENTS SHOWN CLOUDED.	23/05/2018	ΥT	AHM		
DA-B	DRAWINGS AMENDED. ISSUED FOR COUNCIL REVIEW.	13/04/2018	ΥT	AHM		
DA-A	ISSUED FOR DEVELOPMENT APPLICATION	21/11/2017	ΥT	AHM		
ISSUE	AMENDMENT	DATE	DRAWN	CHECKED		
	Drawing is NOT VALID or issued for use, unless checked					






SHADOW - 1PM (21st JUNE)

SHADOW - 3PM (21st JUNE)

GENERAL NOTES:



GENERAL NOTES: Figured dimensions shall be taken in preference to scaling. Drawing to be read in conjunction with information on first page. Check all dimensions and levels on site before commencing work or ordering materials. All existing ground lines & trees location are approximate, therefore to be verified on-site by the builder. Any discrepancies to be verified back to Zhinar Architects before proceeding. All workmanship and materials shall comply with all relevant codes, ordinances, Australian Standards and manufacturer's instructions. Unless noted 'Issued for Construction', drawing not to be used for construction. COPYRIGHT: INFORMATION ON THIS DRAWING IS THE COPYRIGHT OF ZHINAR ARCHITECTS. COPYING OR USING THIS DRAWING IN WHOLE OR PART WITHOUT WRITTEN PERMISSION INFRINGES COPYRIGHT.

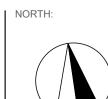

SHEET TITLE: Shadow Diagrams (Winter Solstice) - 1PM-3PM DESIGNED: DRAWN: COMMENCED: SCALE: PRINT: 1:100@A1 A3 SHEET 1:200@A3 or as noted AHM YT May 2017


L.G.A: Cumberland Council

PLOT: Wednesday, 27 June 2018 4:18 PM

SHADOW - 2PM (21st JUNE)



Residential Flat Building 2 Mark St, 1-3 Marsden St Lidcombe, NSW 2141 JOB No.: 8539 DA - D:25B

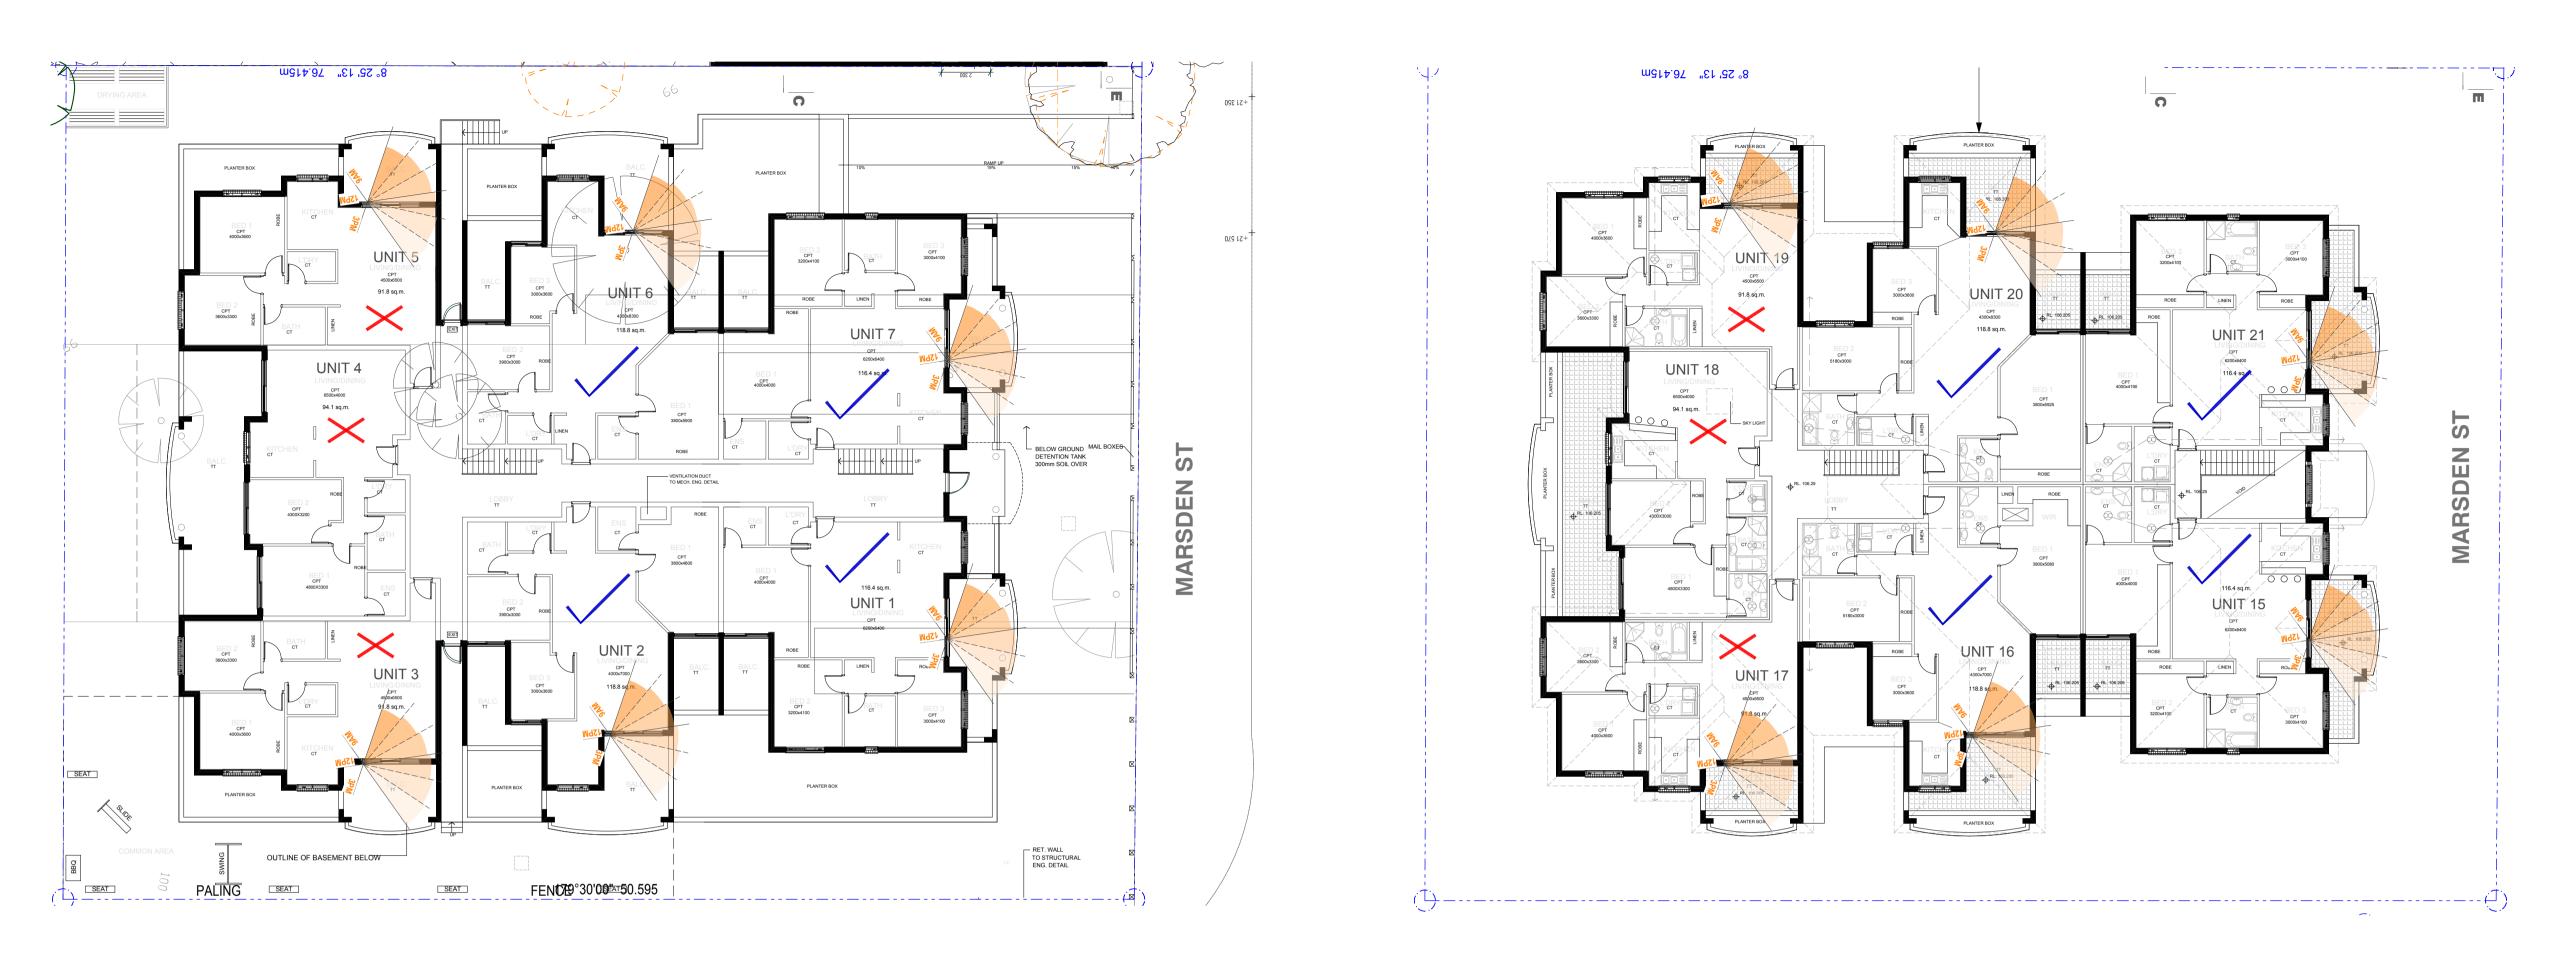

m



DA-D	DRAWINGS AMENDED AS PER JRPP COMMENTS.	27/06/2018	ΥT	AHM		
DA-C	DRAWINGS AMENDED AS PER COUNCIL RFI - MAY '18. AMENDMENTS SHOWN CLOUDED.	23/05/2018	ΥT	AHM		
DA-B	DRAWINGS AMENDED. ISSUED FOR COUNCIL REVIEW.	13/04/2018	ΥT	AHM		
DA-A	ISSUED FOR DEVELOPMENT APPLICATION	21/11/2017	ΥT	AHM		
ISSUE	AMENDMENT	DATE	DRAWN	CHECKED		
	Drawing is NOT VALID or issued for use, unless checked.					

Original Design: Zhinar Architects

# CURRENT SOLAR ACCESS TO EXISTING 10-14 MARSDEN ST

			TOTAL HOURS	SOLAR
<b>UNIT NUMBER &amp; TYPE</b>	UNIT TYPE	SOLAR ACCESS	(2hrs MIN)	COMPLIANCE
Unit 01, 08, 15	3BR	09:00-15:00	6	YES
Unit 02, 09, 16	3BR	09:00-11:30	2.5	YES
Unit 03, 10, 17	2BR	09:00-10:00	1	NO
Unit 04 , 11, 18	2BR		0	NO
Unit 05, 12, 19	2BR	13:30-15:00	1.5	NO
Unit 06, 13, 20	3BR	11:30-15:00	3.5	YES
Unit 07, 14, 21	3BR	09:00-15:00	6	YES

UNITS RECEIVING MIN. 2 HOURS SOLAR DURING WINTER SOLSTICE = 12 UNITS (57.15 %)



MIN. 2 HOURS SOLAR ACCESS




<. 2 HOURS SOLAR ACCESS



GENERAL NOTES:

Figured dimensions shall be taken in preference to scaling. Drawing to be read in conjunction with information on first page. Check all dimensions and levels on site before commencing work or ordering materials. All existing ground lines & trees location are approximate, therefore to be verified on-site by the builder. Any discrepancies to be verified back to Zhinar Architects before proceeding. All workmanship and materials shall comply with all relevant codes, ordinances, Australian Standards and manufacturer's instructions. manufacturer's instructions. Unless noted 'Issued for Construction', drawing not to be used for construction. COPYRIGHT: INFORMATION ON THIS DRAWING IS THE COPYRIGHT OF ZHINAR ARCHITECTS. COPYING OR USING THIS DRAWING IN WHOLE OR PART WITHOUT WRITTEN PERMISSION INFRINGES COPYRIGHT.

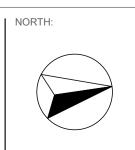

SHEET TITLE: Current Solar Access to Existing 10-14 Marsden St DESIGNED: DRAWN: COMMENCED: SCALE: PRINT: 1:100@A1 A3 SHEET 1:200@A3 or as noted AHM YT May 2017 PLOT: L.G.A: Cumberland Council Wednesday, 27 June 2018 4:18 PM



Residential Flat Building 2 Mark St, 1-3 Marsden St Lidcombe, NSW 2141 JOB No.: 8539 DA - D:25C


# <u>IMPACT OF PROPOSED BUILDING TO EXISTING 10-14 MARSDEN ST</u>



				1			
DA-D	DRAWINGS AMENDED AS PER JRPP COMMENTS.	27/06/2018	ΥT	AHM			
DA-C	DRAWINGS AMENDED AS PER COUNCIL RFI - MAY '18. AMENDMENTS SHOWN CLOUDED.	23/05/2018	ΥT	AHM			
DA-B	DRAWINGS AMENDED. ISSUED FOR COUNCIL REVIEW.	13/04/2018	ΥT	AHM			
DA-A	ISSUED FOR DEVELOPMENT APPLICATION	21/11/2017	ΥT	AHM			
ISSUE	AMENDMENT	DATE	DRAWN	CHECKED			
	Drawing is NOT VALID or issued for use, unless checked.						

NOT RECEIVE SOLAR ACCESS

**Development Application** Original Design: Zhinar Architects

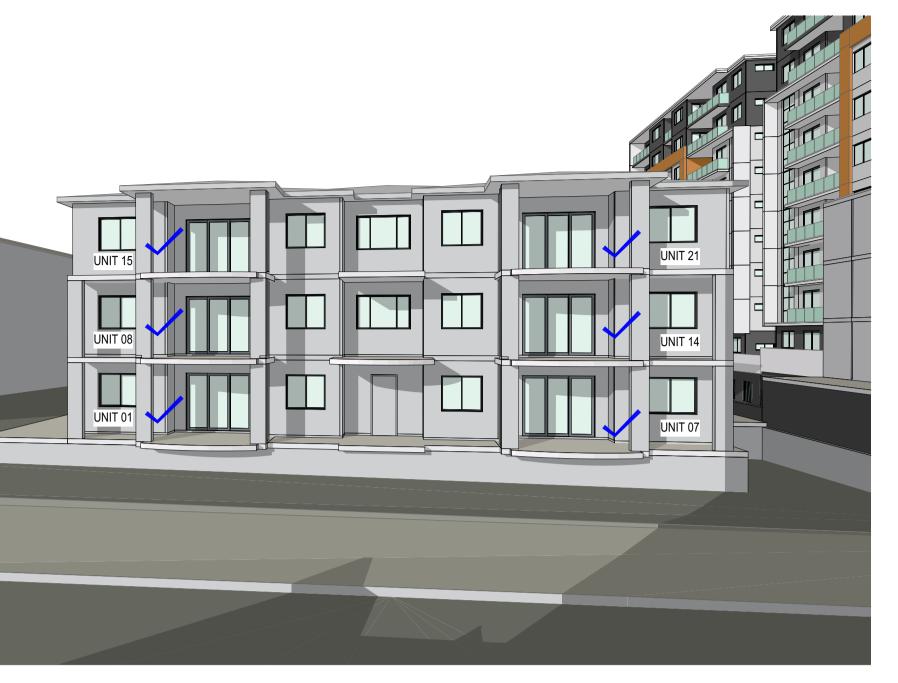





SHADOW ELEVATION - 1PM



(3) SHADOW ELEVATION - 11AM

EXISTING SOLAR ACCESS TO SIX NORTH-FACING UNITS (UNIT 01, 07, 08, 14, 15, 21) AT 10-14 MARSDEN ST : ALL SIX NORTH-FACING UNITS RECEIVE 6 HOURS SOLAR ACCESS ( 9AM - 3PM ) DURING WINTER SOLSTICE

PROPOSED DEVELOPMENT WILL REDUCE THE SOLAR ACCESS TO 10-14 MARSDEN ST BY 3 UNITS ( 14.3 % )



GENERAL NOTES: Figured dimensions shall be taken in preference to scaling. Drawing to be read in conjunction with information on first page. Check all dimensions and levels on site before commencing work or ordering materials. All existing ground lines & trees location are approximate, therefore to be verified on-site by the builder. Any discrepancies to be verified back to Zhinar Architects before proceeding. All workmanship and materials shall comply with all relevant codes, ordinances, Australian Standards and manufacturer's instructions. Unless noted 'Issued for Construction', drawing not to be used for construction. COPYRIGHT: INFORMATION ON THIS DRAWING IS THE COPYRIGHT OF ZHINAR ARCHITECTS. COPYING OR USING THIS DRAWING IN WHOLE OR PART WITHOUT WRITTEN PERMISSION INFRINGES COPYRIGHT.

NORTH:

SHEET TITLE:


Shadow Impact to 10-14 Marsden St (Winter Solstice)						
DESIGNED:	DRAWN:	COMMENCED:	SCALE:	PRINT:		
AHM	ΥT	May 2017	1:100@A1 1:200@A3 or as noted	A3 SHEET		
L.G.A: Cumberland Council PLOT: Wednesday, 27 June 2018 4:18 PM						

**IMPACT OF PROPOSED DEVELOPMENT** TO 10-14 MARSDEN ST DURING WINTER SOLSTICE ( 9AM-3PM ) :

- THREE UNITS (UNIT 01, 08, 15) WILL RECEIVE **3 HOURS** SOLAR ACCESS
- THREE UNITS (UNIT 07, 14, 21) WILL RECEIVE NIL / LESS THAN 2 HOUR SOLAR ACCESS



**Residential Flat Building** 2 Mark St, 1-3 Marsden St Lidcombe, NSW 2141 JOB No.: 8539 DA - D:25D

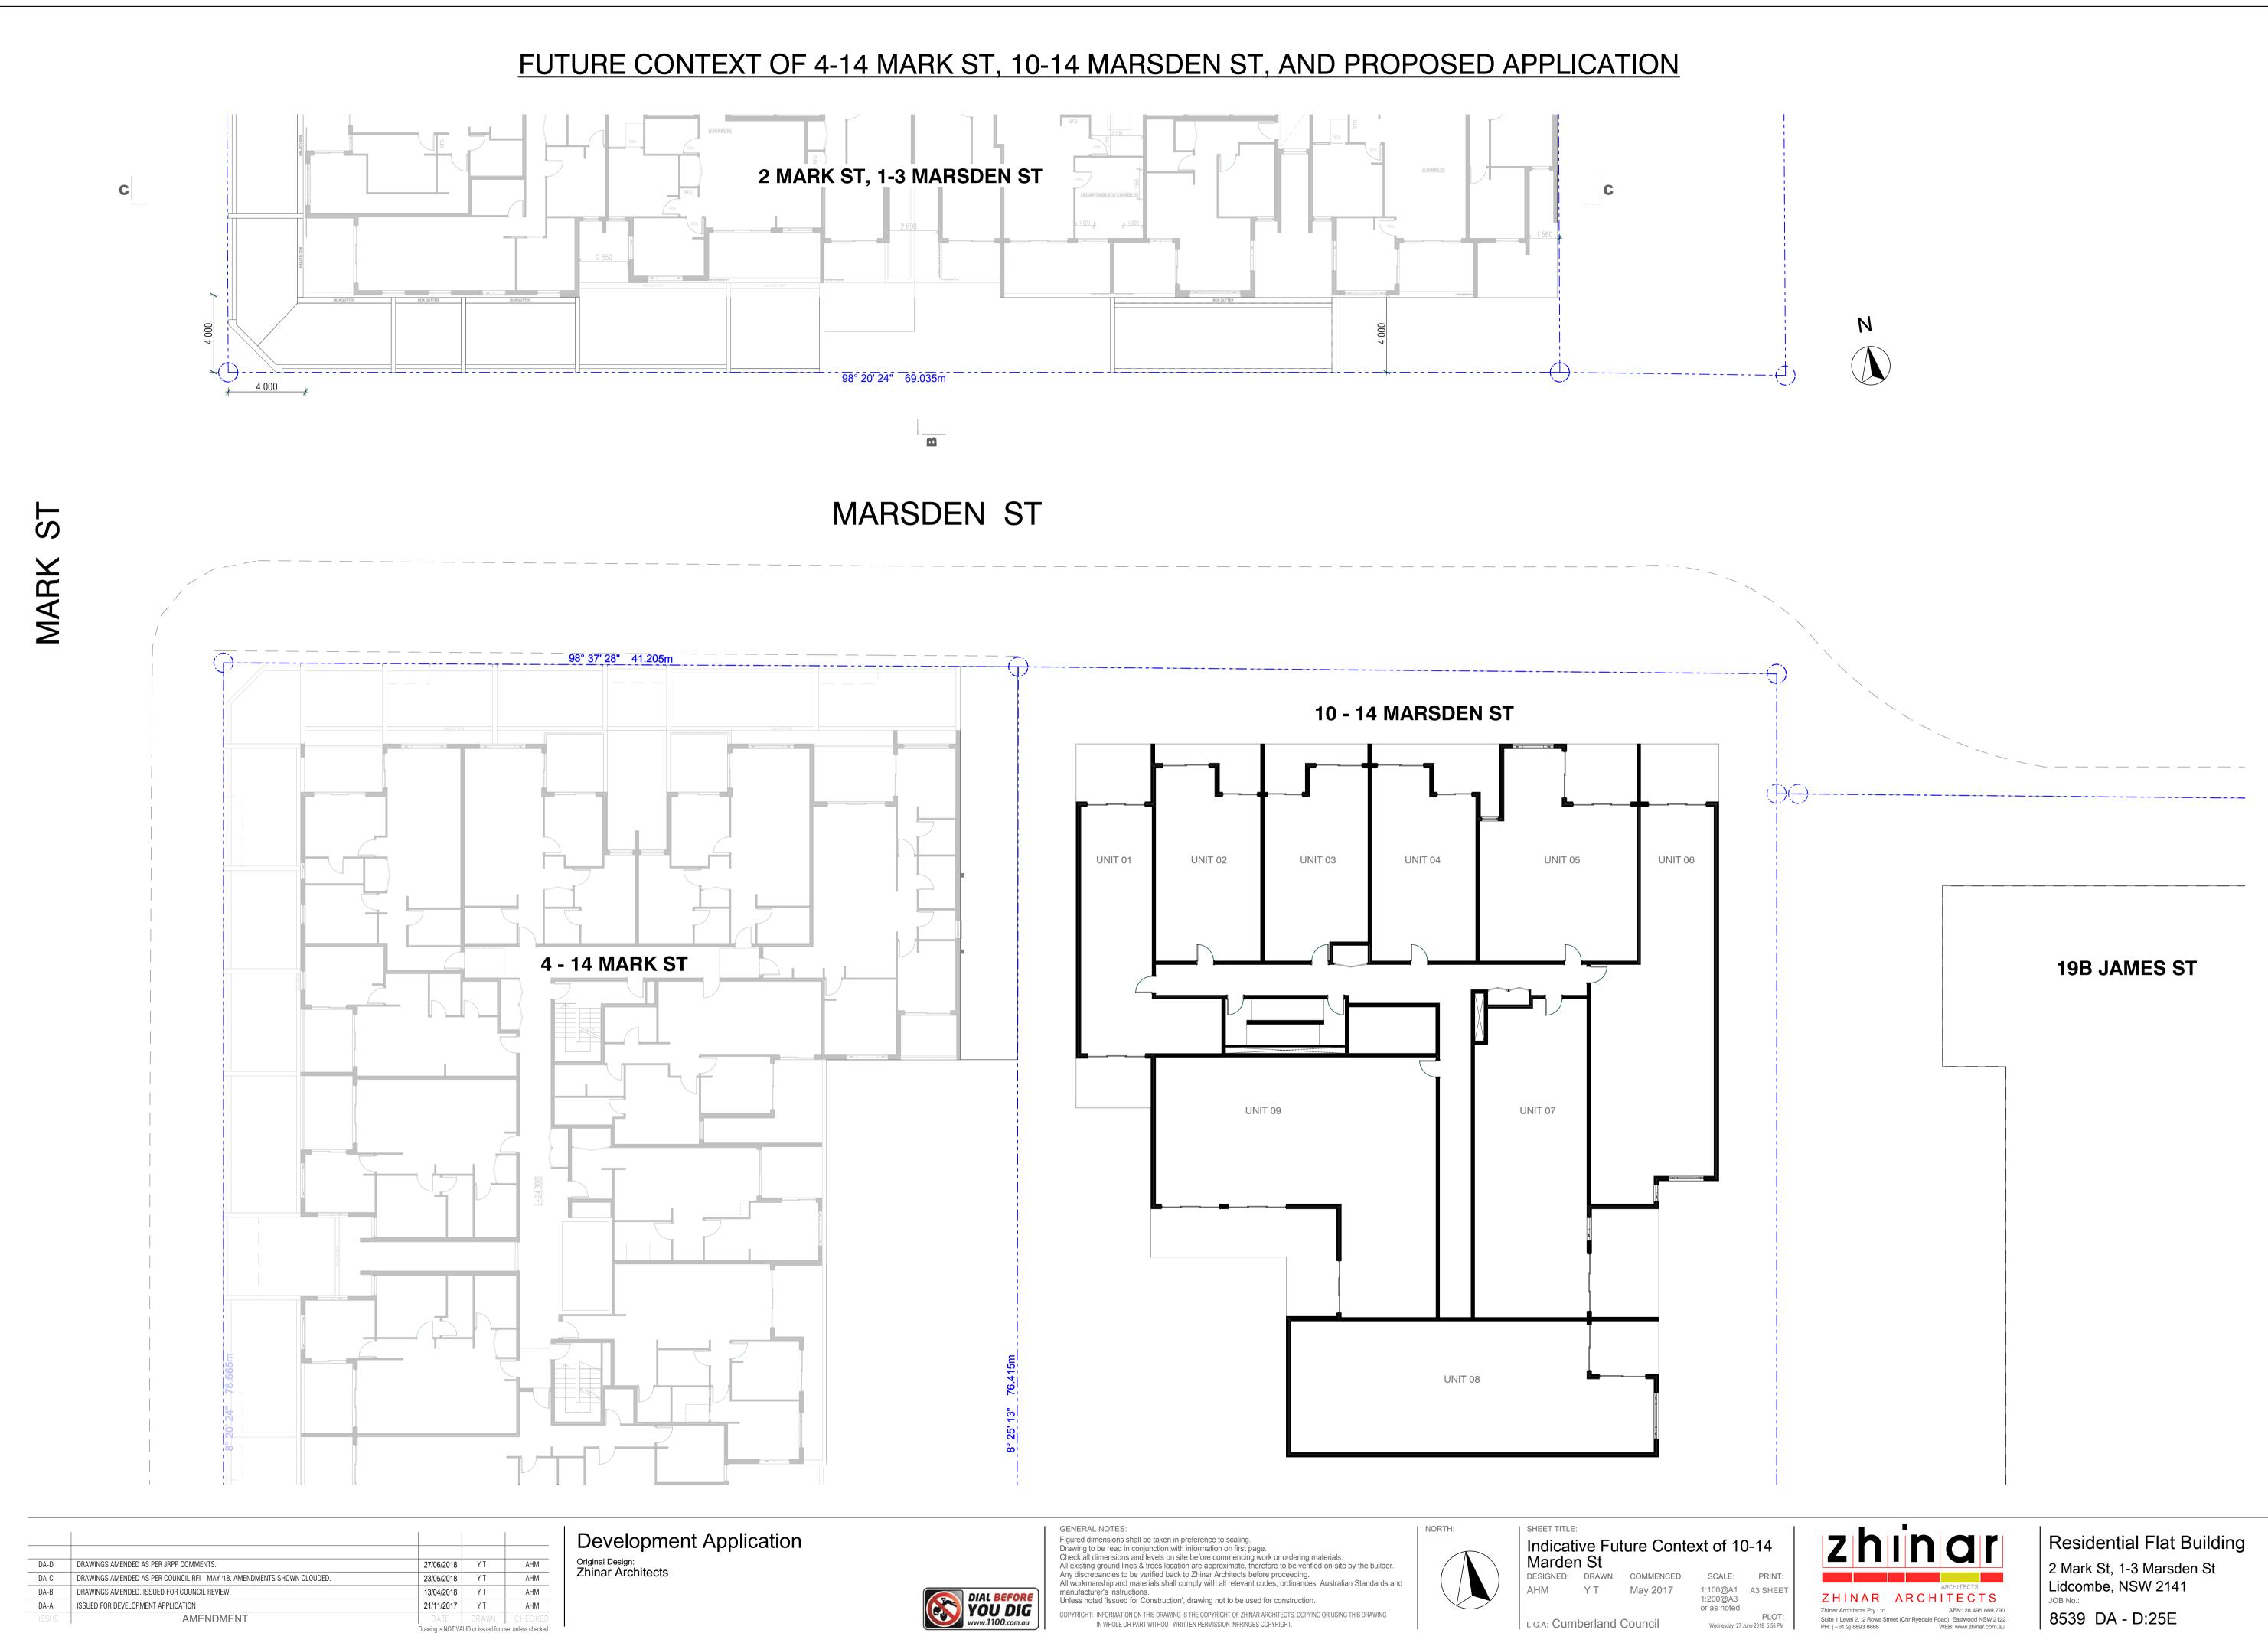





3 PM

## SHADOW IMPACT TO 10-14 MARSDEN ST (FUTURE CONTEXT) :

Number of residential units at 10-14 Marsden St = **84 units** - Ground = Commercials at front + 3 residential units at rear - L1 - L9 (typical) = 9 residential units / floor = 81 units

Number of units receiving nil / less than 2 hours solar during winter solstice = 12 units ( highlighted in green ).

Proposed Development will reduce the solar access to future context of 10-14 Marsden St by 14.3%.



Units receiving min. 2 hours solar during winter solstice

Units receiving less than 2 hours solar during winter solstice



Residential Flat Building 2 Mark St, 1-3 Marsden St Lidcombe, NSW 2141 JOB No.: 8539 DA - D:25F

ISSUE:


D

# IMPACT OF PROPOSED BUILDING TO RECENTLY APPROVED 4-14 MARK ST







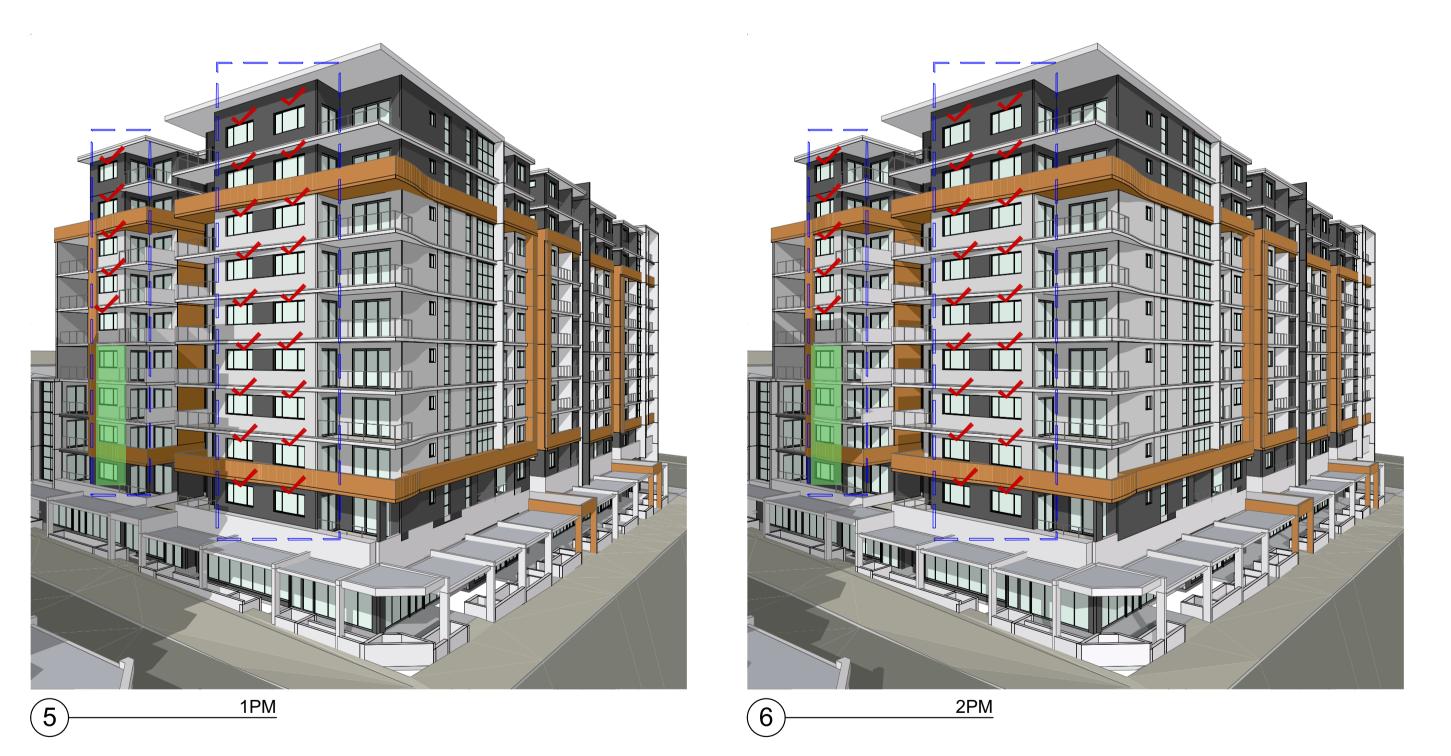


Units receiving min. 2 hours solar during winter solstice

Units receiving less than 2 hours solar during winter solstice

			1		
DA-D	DRAWINGS AMENDED AS PER JRPP COMMENTS.	27/06/2018	ΥT	AHM	
DA-C	DRAWINGS AMENDED AS PER COUNCIL RFI - MAY '18. AMENDMENTS SHOWN CLOUDED.	23/05/2018	ΥT	AHM	
DA-B	DRAWINGS AMENDED. ISSUED FOR COUNCIL REVIEW.	13/04/2018	ΥT	AHM	
DA-A	ISSUED FOR DEVELOPMENT APPLICATION	21/11/2017	ΥT	AHM	
ISSUE	AMENDMENT	DATE	DRAWN	CHECKED	
	Drawing is NOT VALID or issued for use, unless checked.				

**Development Application** Original Design: Zhinar Architects

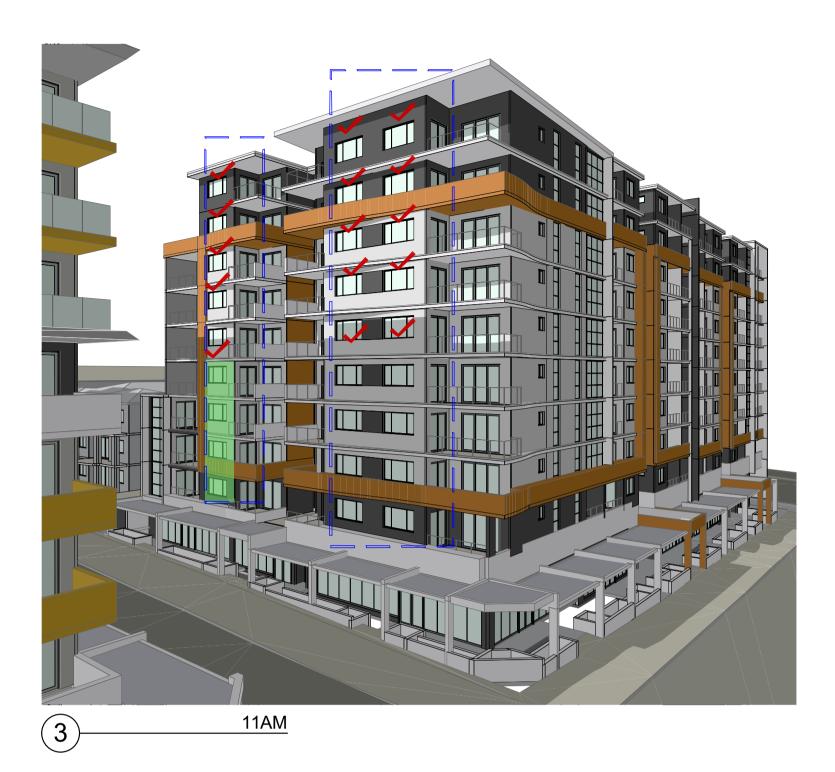





GENERAL NOTES:

Figured dimensions shall be taken in preference to scaling. Drawing to be read in conjunction with information on first page. Check all dimensions and levels on site before commencing work or ordering materials. All existing ground lines & trees location are approximate, therefore to be verified on-site by the builder. Any discrepancies to be verified back to Zhinar Architects before proceeding. All workmanship and materials shall comply with all relevant codes, ordinances, Australian Standards and manufacturer's instructions. Unless noted 'Issued for Construction', drawing not to be used for construction OPYRIGHT: INFORMATION ON THIS DRAWING IS THE COPYRIGHT OF ZHINAR ARCHITECTS. COPYING OR USING THIS DRAWING IN WHOLE OR PART WITHOUT WRITTEN PERMISSION INFRINGES COPYRIGHT.

NORTH:

SHEET TITLE:

L.G.A: Cumberland Council


Shadow Impact to 4-14 Mark St (Winter Solstice) DESIGNED: DRAWN: COMMENCED: SCALE: PRINT: 1:100@A1 A3 SHEET 1:200@A3 or as noted AHM YT May 2017 PLOT

Wednesday, 27 June 2018 4:18 PM



Residential Flat Building 2 Mark St, 1-3 Marsden St Lidcombe, NSW 2141 JOB No.: 8539 DA - D:25G

# IMPACT OF PROPOSED BUILDING TO RECENTLY APPROVED 4-14 MARK ST

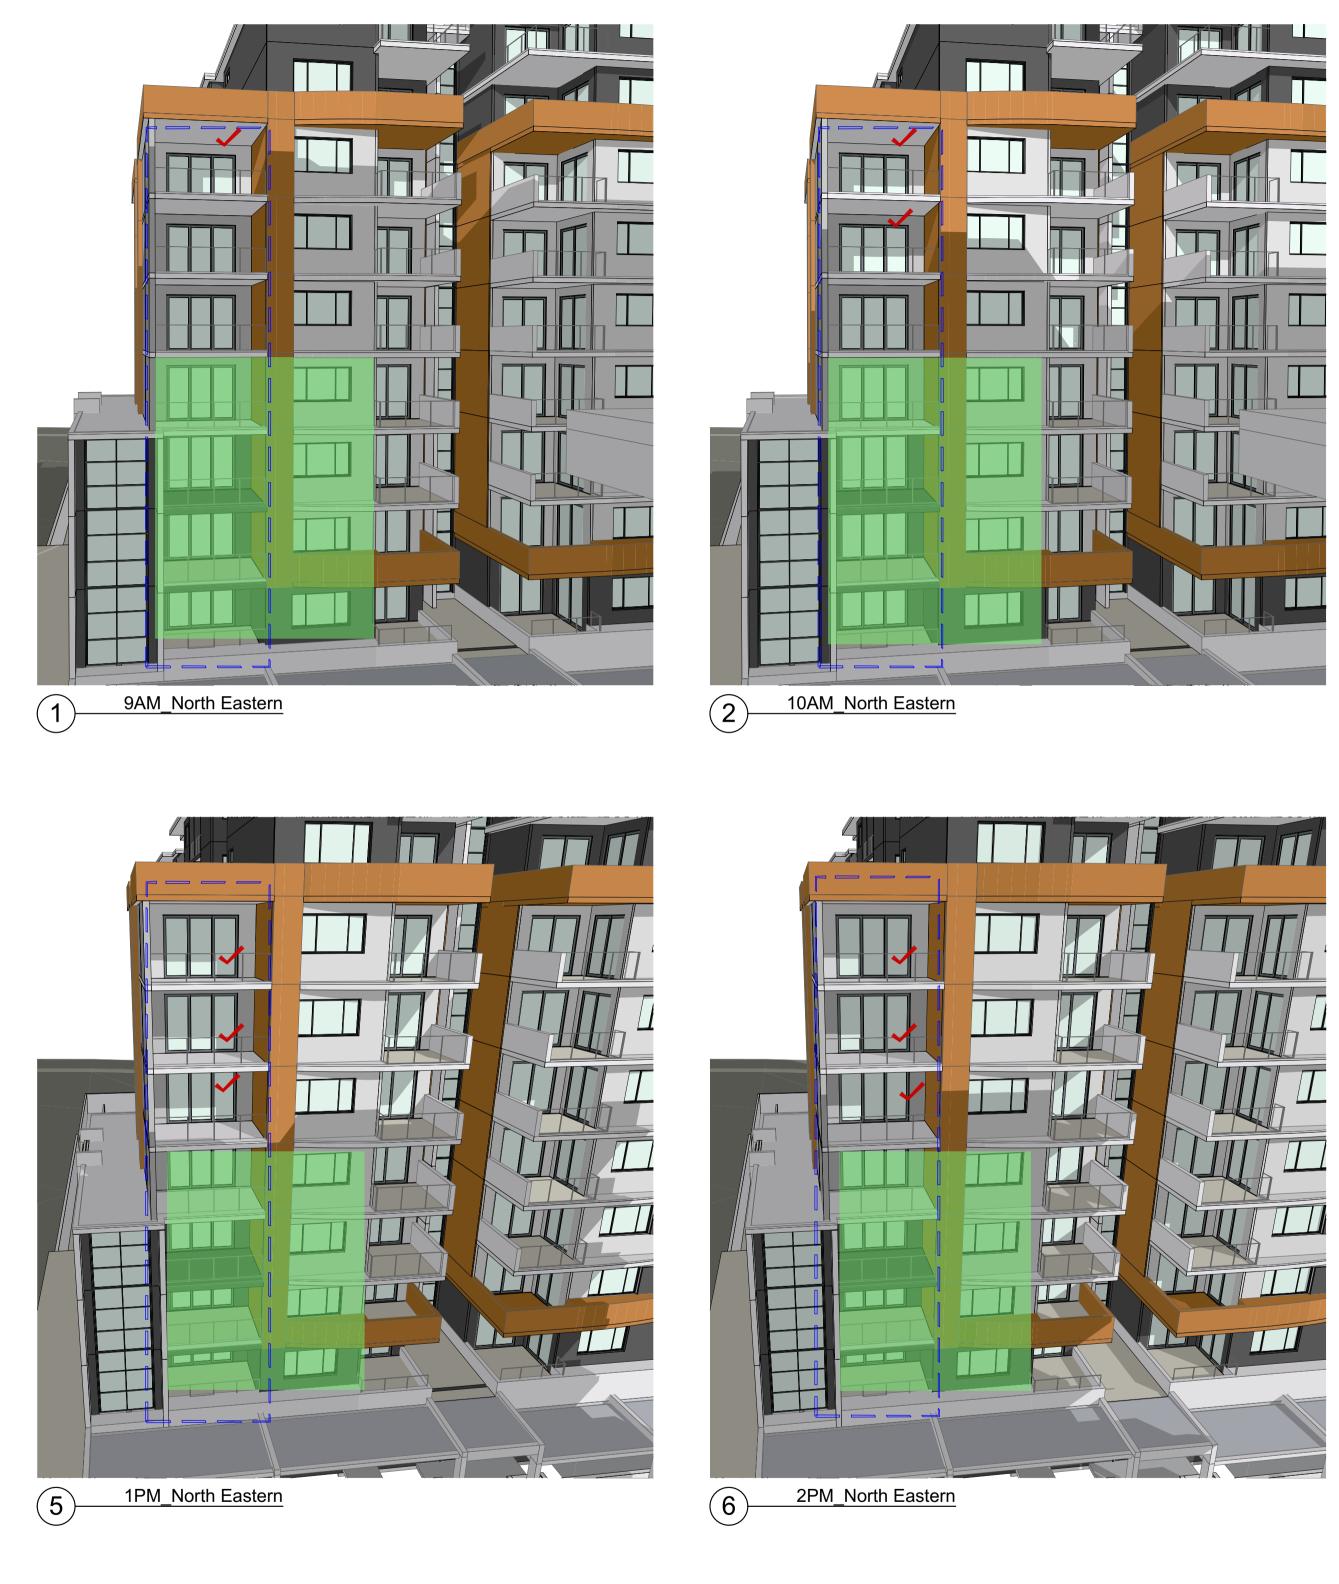

**IMPACT OF PROPOSED DEVELOPMENT** TO RECENTLY APPROVED DEVELOPMENT 4-14 MARK ST DURING WINTER SOLSTICE ( 9AM-3PM ) : EIGHT NORTH-FACING UNITS (HIGHLIGHTED IN GREEN) WILL RECEIVE NIL / LESS THAN 2 HOUR SOLAR ACCESS.

PROPOSED DEVELOPMENT WILL REDUCE THE SOLAR ACCESS TO 4 - 14 MARK ST BY 8 UNITS (4.85%)

			L	
DA-D	DRAWINGS AMENDED AS PER JRPP COMMENTS.	27/06/2018	ΥT	AHM
DA-C	DRAWINGS AMENDED AS PER COUNCIL RFI - MAY '18. AMENDMENTS SHOWN CLOUDED.	23/05/2018	ΥT	AHM
DA-B	DRAWINGS AMENDED. ISSUED FOR COUNCIL REVIEW.	13/04/2018	ΥT	AHM
DA-A	ISSUED FOR DEVELOPMENT APPLICATION	21/11/2017	ΥT	AHM
ISSUE	AMENDMENT	DATE	DRAWN	CHECKED
Drawing is NOT VALID or issued for use, unless checked.				

**Development Application** Original Design: Zhinar Architects







3PM\_North Eastern (7



GENERAL NOTES:

Figured dimensions shall be taken in preference to scaling. Drawing to be read in conjunction with information on first page. Check all dimensions and levels on site before commencing work or ordering materials. All existing ground lines & trees location are approximate, therefore to be verified on-site by the builder. Any discrepancies to be verified back to Zhinar Architects before proceeding. All workmanship and materials shall comply with all relevant codes, ordinances, Australian Standards and manufacturer's instructions. Unless noted 'Issued for Construction', drawing not to be used for construction. COPYRIGHT: INFORMATION ON THIS DRAWING IS THE COPYRIGHT OF ZHINAR ARCHITECTS. COPYING OR USING THIS DRAWING IN WHOLE OR PART WITHOUT WRITTEN PERMISSION INFRINGES COPYRIGHT.

NORTH:

SHEET TITLE: Shadow Impact to 4-14 Mark St (Winter Solstice) DESIGNED: DRAWN: COMMENCED: AHM YT May 2017

L.G.A: Cumberland Council

SCALE: PRINT 1:100@A1 A3 SHEET 1:200@A3 or as noted PLOT Wednesday, 27 June 2018 4:18 PM

✓ Units receiving min. 2 hours solar during winter solstice

Units receiving less than 2 hours solar during winter solstice



Residential Flat Building 2 Mark St, 1-3 Marsden St Lidcombe, NSW 2141 JOB No.: 8539 DA - D:25H



DA-D	DRAWINGS AMENDED AS PER JRPP COMMENTS.	28/06/2018	ΥT	AHM
DA-C	DRAWINGS AMENDED AS PER COUNCIL RFI - MAY '18. AMENDMENTS SHOWN CLOUDED.	23/05/2018	ΥT	AHM
DA-B	DRAWINGS AMENDED. ISSUED FOR COUNCIL REVIEW.	13/04/2018	ΥT	AHM
DA-A	ISSUED FOR DEVELOPMENT APPLICATION	21/11/2017	ΥT	AHM
ISSUE	AMENDMENT	DATE	DRAWN	CHECKED
Drawing is NOT VALID or issued for use, unless checked				

GENERAL NOTES:



Figured dimensions shall be taken in preference to scaling. Drawing to be read in conjunction with information on first page. Check all dimensions and levels on site before commencing work or ordering materials. All existing ground lines & trees location are approximate, therefore to be verified on-site by the builder. Any discrepancies to be verified back to Zhinar Architects before proceeding. All workmanship and materials shall comply with all relevant codes, ordinances, Australian Standards and manufacturace instructions. manufacturer's instructions. Unless noted 'Issued for Construction', drawing not to be used for construction. COPYRIGHT: INFORMATION ON THIS DRAWING IS THE COPYRIGHT OF ZHINAR ARCHITECTS. COPYING OR USING THIS DRAWING IN WHOLE OR PART WITHOUT WRITTEN PERMISSION INFRINGES COPYRIGHT.

NORTH:

SHEET TITLE: FUTURE CONTEXT

L.G.A: Cumberland Council

DESIGNED: DRAWN: COMMENCED: AHM YT May 2017

SCALE: PRINT: 1:100@A1 A3 SHEET 1:200@A3 or as noted PLOT Thursday, 28 June 2018 11:34 AM



**Residential Flat Building** 2 Mark St, 1-3 Marsden St Lidcombe, NSW 2141 JOB No.: 8539 DA - D:251

# <u>IMPACT OF PROPOSED BUILDING TO FUTURE CONTEXT OF 10-14 MARSDEN ST & RECENTLY APPROVED 4-14 MARK ST</u>





DA-D	DRAWINGS AMENDED AS PER JRPP COMMENTS.	27/06/2018	ΥT	AHM	
DA-C	DRAWINGS AMENDED AS PER COUNCIL RFI - MAY '18. AMENDMENTS SHOWN CLOUDED.	23/05/2018	ΥT	AHM	
DA-B	DRAWINGS AMENDED. ISSUED FOR COUNCIL REVIEW.	13/04/2018	ΥT	AHM	
DA-A	ISSUED FOR DEVELOPMENT APPLICATION	21/11/2017	ΥT	AHM	
ISSUE	AMENDMENT	DATE	DRAWN	CHECKED	
	Drawing is NOT VALID or issued for use, unless checked				

**Development Application** Original Design: Zhinar Architects



SHADOW - 9AM (21st JUNE)





SHADOW - 11AM (21st JUNE)

> GENERAL NOTES: GENERAL NOTES: Figured dimensions shall be taken in preference to scaling. Drawing to be read in conjunction with information on first page. Check all dimensions and levels on site before commencing work or ordering materials. All existing ground lines & trees location are approximate, therefore to be verified on-site by the builder. Any discrepancies to be verified back to Zhinar Architects before proceeding. All workmanship and materials shall comply with all relevant codes, ordinances, Australian Standards and manufacturer's instructions. Unless noted 'Issued for Construction', drawing not to be used for construction. COPYRIGHT: INFORMATION ON THIS DRAWING IS THE COPYRIGHT OF ZHINAR ARCHITECTS. COPYING OR USING THIS DRAWING IN WHOLE OR PART WITHOUT WRITTEN PERMISSION INFRINGES COPYRIGHT.

NORTH:

### SHEET TITLE: Shadow to Future 10-14 Marsden St

DESIGNED:	DRAWN:	COMMENCED:	SCALE:	PRINT:
AHM	ΥT	May 2017	1:100@A1 1:200@A3 or as noted	A3 SHEET
L.G.A: Cum	berland (	Wednesday, 27 J	PLOT: une 2018 4:18 PM	



## SHADOW - 10AM (21st JUNE)



SHADOW - 12PM (21st JUNE)

Residential Flat Building 2 Mark St, 1-3 Marsden St Lidcombe, NSW 2141 JOB No.: 8539 DA - D:25J



		1	L	I.
DA-D	DRAWINGS AMENDED AS PER JRPP COMMENTS.	27/06/2018	ΥT	AHM
DA-C	DRAWINGS AMENDED AS PER COUNCIL RFI - MAY '18. AMENDMENTS SHOWN CLOUDED.	23/05/2018	ΥT	AHM
DA-B	DRAWINGS AMENDED. ISSUED FOR COUNCIL REVIEW.	13/04/2018	ΥT	AHM
DA-A	ISSUED FOR DEVELOPMENT APPLICATION	21/11/2017	ΥT	AHM
ISSUE	AMENDMENT	DATE	DRAWN	CHECKED
		Drawing is NOT V	ALID or issued for u	se, unless checked.





SHADOW - 1PM (21st JUNE)

SHADOW - 3PM (21st JUNE)

GENERAL NOTES:



GENERAL NOTES: Figured dimensions shall be taken in preference to scaling. Drawing to be read in conjunction with information on first page. Check all dimensions and levels on site before commencing work or ordering materials. All existing ground lines & trees location are approximate, therefore to be verified on-site by the builder. Any discrepancies to be verified back to Zhinar Architects before proceeding. All workmanship and materials shall comply with all relevant codes, ordinances, Australian Standards and manufacturer's instructions. Unless noted 'Issued for Construction', drawing not to be used for construction. COPYRIGHT: INFORMATION ON THIS DRAWING IS THE COPYRIGHT OF ZHINAR ARCHITECTS. COPYING OR USING THIS DRAWING IN WHOLE OR PART WITHOUT WRITTEN PERMISSION INFRINGES COPYRIGHT.

NORTH:

SHEET TITLE:

Shadow to Future 10-14 Marsden St							
DESIGNED:	DRAWN:	COMMENCED:	SCALE:	PRINT:			
AHM	ΥT	May 2017	1:100@A1 1:200@A3 or as noted	A3 SHEET			
L.G.A: Cumberland Council PLOT: Wednesday, 27 June 2018 4:18 PM							


SHADOW - 2PM (21st JUNE)




Residential Flat Building 2 Mark St, 1-3 Marsden St Lidcombe, NSW 2141 JOB No.: 8539 DA - D:25K





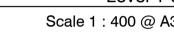



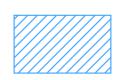

## AREA INCLUDED IN GFA CALCULATION


Ground Floor Level 1-3 Level 4-7 Level 8 Level 9

1,117.65 m2 1,234.28 m2 x 3 = 3,702.84 m2 1,207.27 m2 x 4 = 4,829.08 m2 1,051.47 m2 1,010.33 m2

TOTAL PROPOSED AREA

11,711.37 m2(FSR 4.8:1)

Figured dimensions shall be taken in preference to scaling. Drawing to be read in conjunction with information on first page. Check all dimensions and levels on site before commencing work or ordering materials. All existing ground lines & trees location are approximate, therefore to be verified on-site by the builder. Any discrepancies to be verified back to Zhinar Architects before proceeding. All workmanship and materials shall comply with all relevant codes, ordinances, Australian Standards and manufacturer's instructions. manufacturer's instructions. Unless noted 'Issued for Construction', drawing not to be used for construction. COPYRIGHT: INFORMATION ON THIS DRAWING IS THE COPYRIGHT OF ZHINAR ARCHITECTS. COPYING OR USING THIS DRAWING IN WHOLE OR PART WITHOUT WRITTEN PERMISSION INFRINGES COPYRIGHT.

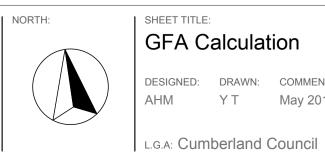


### SHEET TITLE: GFA Calculation


DESIGNED: DRAWN: COMMENCED: YT May 2017 AHM

SCALE: PRINT: 1:100@A1 A3 SHEET 1:200@A3 or as noted PLOT: Friday, 22 June 2018 2:28 PM



Residential Flat Building 2 Mark St, 1-3 Marsden St Lidcombe, NSW 2141 JOB No.: 8539 DA - D:26

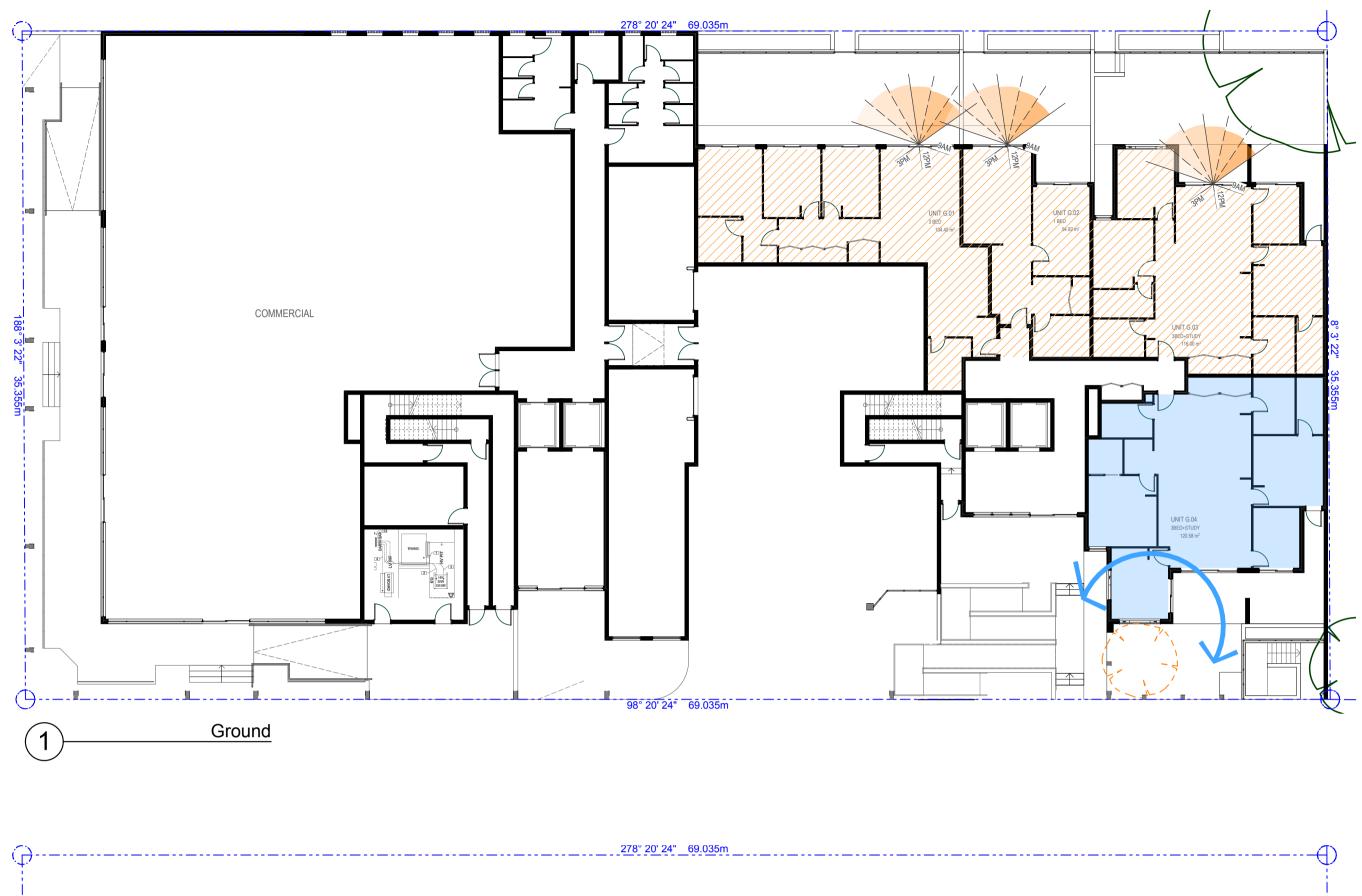


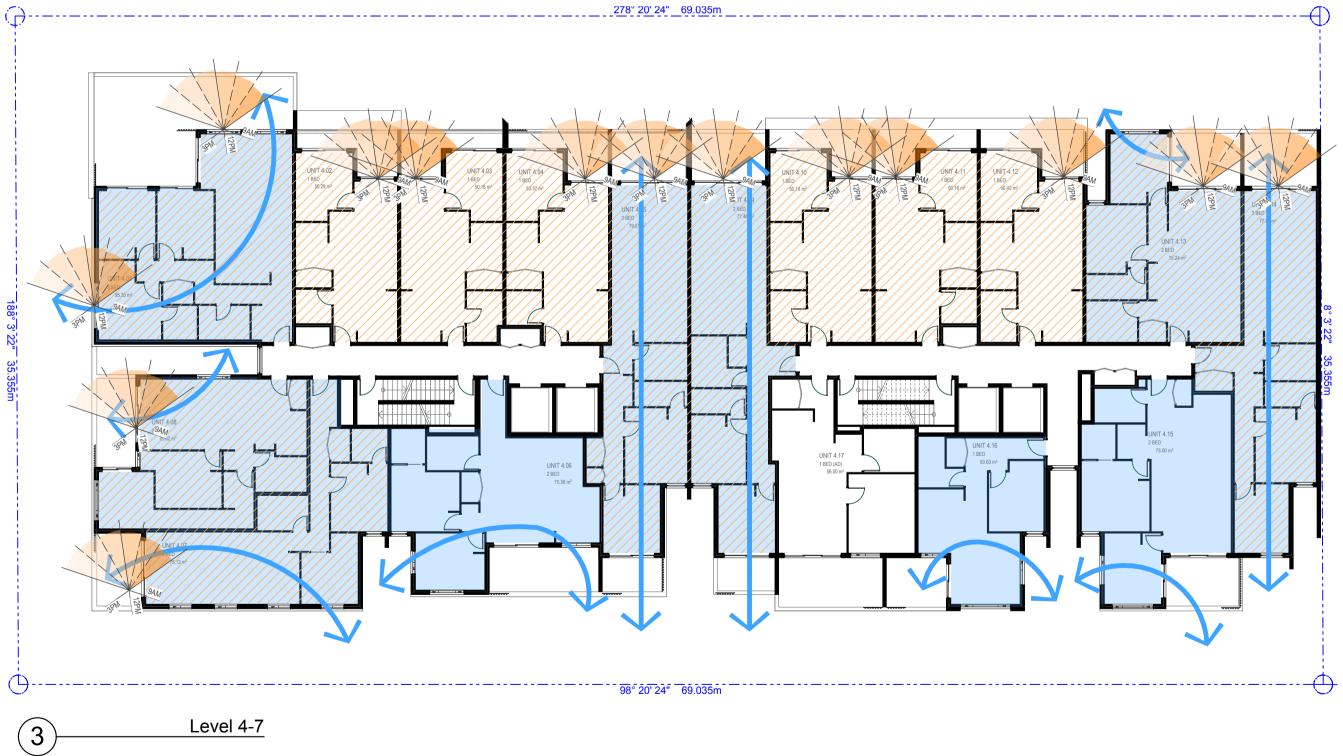

DA-D	DRAWINGS AMENDED AS PER JRPP COMMENTS.	22/06/2018	ΥT	AHM	
DA-C	DRAWINGS AMENDED AS PER COUNCIL RFI - MAY '18. AMENDMENTS SHOWN CLOUDED.	23/05/2018	ΥT	AHM	
DA-B	DRAWINGS AMENDED. ISSUED FOR COUNCIL REVIEW.	13/04/2018	ΥT	AHM	
DA-A	ISSUED FOR DEVELOPMENT APPLICATION	21/11/2017	ΥT	AHM	
ISSUE	AMENDMENT	DATE	DRAWN	CHECKED	
		Drawing is NOT VALID or issued for use, unless checked.			

elopment Application <sup>sign:</sup> Architects



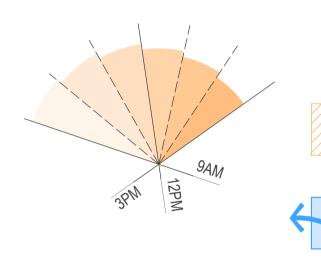

UNIT RECEIVING MIN. 2 HOURS SOLAR ACCESS TO LIVING ROOM DURING WINTER SOLSTICE (21st JUNE)

UNIT WITH CROSS VENTILATION



GENERAL NOTES:

GENERAL NOTES: Figured dimensions shall be taken in preference to scaling. Drawing to be read in conjunction with information on first page. Check all dimensions and levels on site before commencing work or ordering materials. All existing ground lines & trees location are approximate, therefore to be verified on-site by the builder. Any discrepancies to be verified back to Zhinar Architects before proceeding. All workmanship and materials shall comply with all relevant codes, ordinances, Australian Standards and manufacturer's instructions. Unless noted 'Issued for Construction', drawing not to be used for construction. COPYRIGHT: INFORMATION ON THIS DRAWING IS THE COPYRIGHT OF ZHINAR ARCHITECTS. COPYING OR USING THIS DRAWING IN WHOLE OR PART WITHOUT WRITTEN PERMISSION INFRINGES COPYRIGHT.


NORTH:

SHEET TITLE: Solar & Cross Ventilation Diagrams 01

UT				
DESIGNED:	DRAWN:	COMMENCED:	SCALE:	PRINT:
AHM	ΥT	May 2017	1:100@A1 1:200@A3 or as noted	A3 SHEET
l.g.a: Cum	berland	Council	Friday, 22 J	PLOT: une 2018 2:29 PM



Residential Flat Building 2 Mark St, 1-3 Marsden St Lidcombe, NSW 2141 JOB No.: 8539 DA - D:27

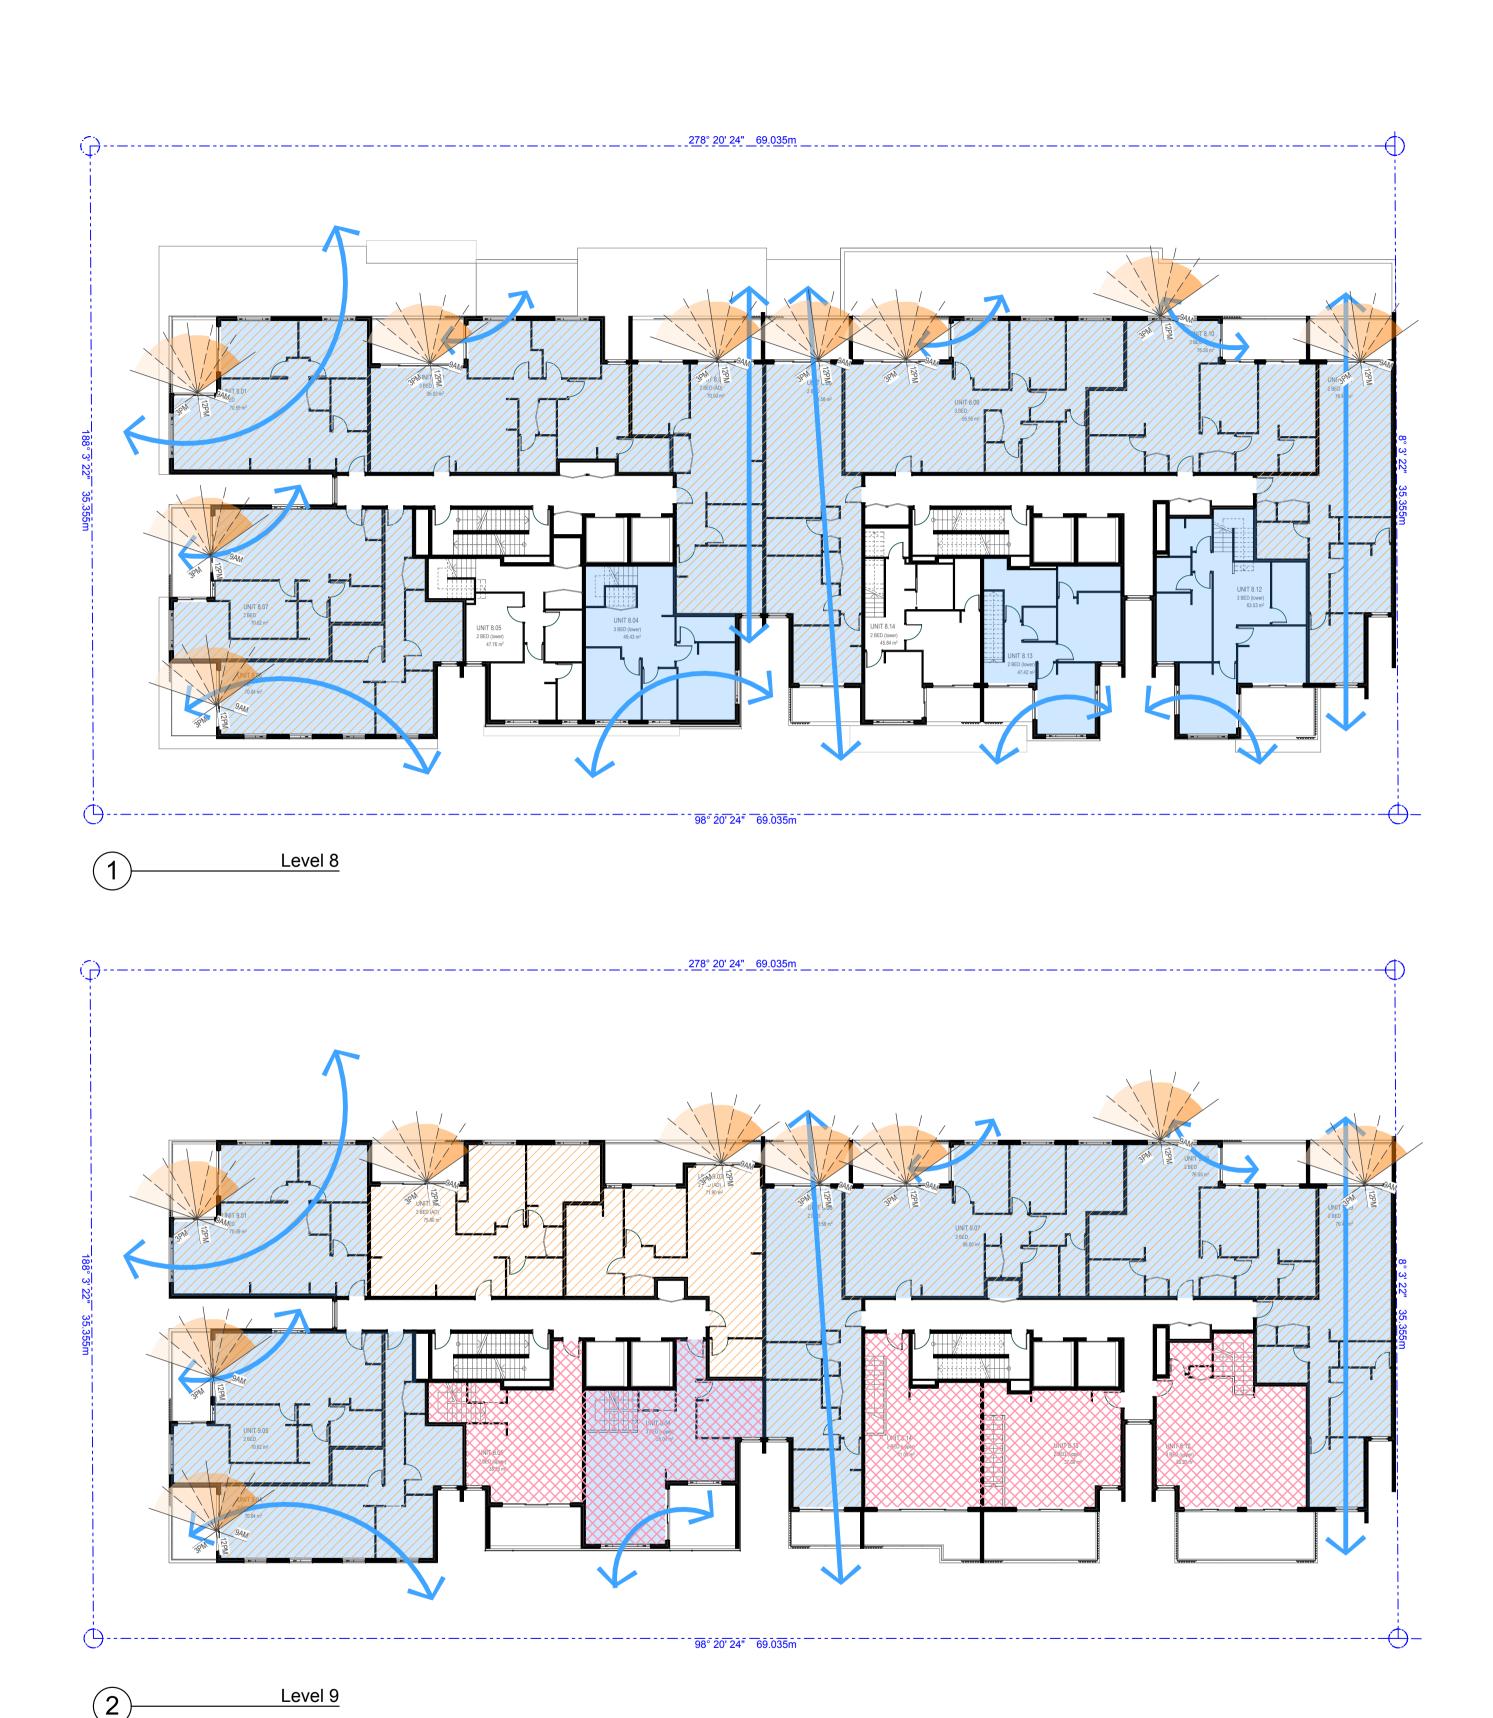

DA-D	DRAWINGS AMENDED AS PER JRPP COMMENTS.	22/06/2018	ΥT	AHM
DA-C	DRAWINGS AMENDED AS PER COUNCIL RFI - MAY '18. AMENDMENTS SHOWN CLOUDED.	23/05/2018	ΥT	AHM
DA-B	DRAWINGS AMENDED. ISSUED FOR COUNCIL REVIEW.	13/04/2018	ΥT	AHM
DA-A	ISSUED FOR DEVELOPMENT APPLICATION	21/11/2017	ΥT	AHM
ISSUE	AMENDMENT	DATE	DRAWN	CHECKED
		Drawing is NOT VA	ALID or issued for u	se, unless checked.



UNIT NUMBER & TYPE	UNIT TYPE	CROSS VENT.	SOLAR ACCESS	TOTAL HOURS (2hrs MIN)	SOLAR COMPLIANCE	P.O.S ( m2 )
Unit G.01	3BR (AD)	NO	9:00 - 15:00	6	YES	66.43
Unit G.02	1BR (AD)	NO	9:00 - 15:00	6	YES	38.13
Unit G.03	3BR	NO	10:30-14:00	3.5	YES	78.62
Unit G.04	3BR	YES		0	NO	25 + 26.77 = 51.77
Unit 1.01 – 3.01 (typical)	1BR	YES	12:00 - 15:00	3	YES	8.39
Unit 1.02 – 3.02 (typical)	1BR (AD)	YES	9:00 - 15:00	6	YES	10.29
Unit 1.03 – 3.03 (typical), Unit 4.02 – 7.02 (typical)	1BR	NO	10:00-12:30	2.5	YES	13.82
Unit 1.04 – 3.04 (typical), Unit 4.03 – 7.03 (typical)	1BR	NO	10:00-12:30	2.5	YES	8.56
Unit 1.05 – 3.05 (typical), Unit 4.04 – 7.04 (typical)	1BR	NO	10:30 - 13:00	2.5	YES	9.03
Unit 1.06 – 3.06 (typical), Unit 4.05 – 7.05 (typical)	2BR	YES	10:00 - 13:30	3.5	YES	10.61+ 6.04
Unit 1.07 – 3.07 (typical), Unit 4.06 – 7.06 (typical)	2BR	YES		0	NO	14.45
Unit 1.08 – 3.08 (typical), Unit 4.07 – 7.07 (typical)	2BR	YES	14:00 - 15:00	1	NO	10
Unit 1.09 – 3.09 (typical), unit 4.08 – 7.08 (typical)	2BR	YES	13:00 - 15:00	2	YES	10.77
Unit 1.10 – 3.10 (typical), Unit 4.09 – 7.09 (typical)	2BR	YES	10:00 - 13:00	3	YES	10.8 + 5.93 = 16.73
Unit 1.11 – 3.11 (typical), Unit 4.10 – 7.10 (typical)	1BR	NO	10:30 - 13:00	2.5	YES	8.61
Unit 1.12 – 3.12 (typical), Unit 4.11 – 7.11 (typical)	1BR	NO	10:00-12:30	2.5	YES	8.56
Unit 1.13 – 3.13 (typical), unit 4.12 – 7.12 (typical)	1BR	NO	10:00 - 14:00	4	YES	8.47
Unit 1.14 – 3.14 (typical), Unit 4.13 – 7.13 (typical)	2BR	YES	10:00 - 13:00	3	YES	10.89
Unit 1.15 – 3.15 (typical), Unit 4.14 – 7.14 (typical)	2BR	YES	10:00 - 13:00	3	YES	11.55
Unit 1.16 – 3.16 (typical), unit 4.15 – 7.15 (typical)	2BR	YES		0	NO	10.34
Unit 1.17 – 3.17 (typical), unit 4.16 – 7.16 (typical)	1BR	YES		0	NO	8.55
Unit 1.18 – 3.18 (typical), unit 4.17 – 7.17 (typical)	1BR (AD)	NO		0	NO	14.85
Unit 4.01 – 7.01	3BR	YES	9:00 - 15:00	6	YES	15.09
Unit 8.01 – 9.01 (typical)	2BR	YES	11:00 - 15:00	4	YES	10.17
Unit 8.02	3BR	YES	10:00 - 14:00	4	YES	12.15
Unit 8.03	2BR (AD)	YES	9:30 - 14:30	5	YES	15.66
Unit 8.04	3BR	YES	(skylight)	6	YES	12.39
Unit 8.05	2BR	NO	(skylight)	6	YES	10.56
Unit 8.06, Unit 9.04 (typical)	2BR	YES	14:00 - 15:00	1	NO	10
Unit 8.07, Unit 9.05 (typical)	2BR	YES	13:00 - 15:00	2	YES	10.77
Unit 8.08, Unit 9.06 (typical)	2BR	YES	10:00 - 14:00	4	YES	10.23 + 6.46 = 16.69
Unit 8.09, Unit 9.07 (typical)	3BR	YES	9:30 - 14:00	4.5	YES	12.17
Unit 8.10, Unit 9.08 (typical)	2BR	YES	9:00 - 15:00	6	YES	10.17
Unit 8.11, Unit 9.09 (typical)	2BR	YES	9:00 - 14:00	5	YES	10.12 + 33.65 = 43.77
Unit 8.12	3BR	YES	(skylight)	6	YES	10.42 + 19.33 = 29.75
Unit 8.13	2BR	YES	(skylight)	6	YES	5+ 16 = 21
Unit 8.14	2BR	NO	(skylight)	6	YES	5.54 + 12.77 = 18.31
Unit 9.02	2BR (AD)	NO	9:30 - 14:00	4.5	YES	10.69
Unit 9.03	2BR (AD)	NO	9:00 - 15:00	6	YES	14.46

93 / 149 UNITS

62.42% (min. 60%)



NATURAL CROSS VENTILATION 94 OF 151 UNITS = 62.25%

UNIT RECEIVING MIN. 2 HOURS SOLAR ACCESS TO LIVING ROOM DURING WINTER SOLSTICE (21st JUNE)

UNIT WITH CROSS VENTILATION

UNIT RECEIVING SOLAR ACCESS FROM ROOF SKYLIGHT






113 OF 151 UNITS = 74.83%

**Objective 4A-1** 

Design criteria

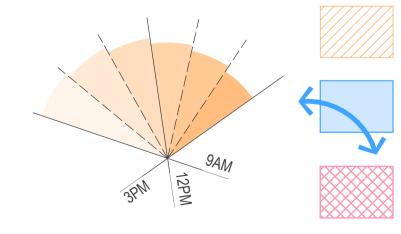



GENERAL NOTES:

Figured dimensions shall be taken in preference to scaling. Drawing to be read in conjunction with information on first page. Check all dimensions and levels on site before commencing work or ordering materials. All existing ground lines & trees location are approximate, therefore to be verified on-site by the builder. Any discrepancies to be verified back to Zhinar Architects before proceeding. All workmanship and materials shall comply with all relevant codes, ordinances, Australian Standards and manufacturer's instructions. Unless noted 'Issued for Construction', drawing not to be used for construction.

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111 / 149 UNITS 74.50%

(min. 70%)

PLOT



Residential Flat Building 2 Mark St, 1-3 Marsden St Lidcombe, NSW 2141 JOB No.: 8539 DA - D:28